



**LOCAL FIRE AUTHORITY REVIEW**


To facilitate the Division of the State Architect's (DSA) approval of the Fire/Life Safety portion of a project, DSA requires Local Fire Authority (LFA) review of certain elements as identified in this form. Use of this form is mandatory for projects that add square footage to a campus or if any item on this form is relevant to the project. For additional information, see DSA 810 Instructions and DSA Policy 09-01.

**PROJECT INFORMATION**  
 School District/Owner: Santa Monica-Malibu Unified School District  
 Project Name/School: Point Dume E.S. Temporary Housing Project  
 Project Address: 6955 Fernhill Drive, Malibu, CA 90265

**LOCAL FIRE AUTHORITY (LFA)**  
 LFA Agency Name: LACSFD  
 LFA Reviewer Name: C. KENNELLY Title: FPEA II  
 Work Email: Title Work Telephone Number: 818-260-2241  
 I have reviewed and responded to the applicable items for this project as listed below.  
 Note: Only sign this form when it is imaged onto the site plan. A loose form is not acceptable to DSA.  
 LFA Reviewer's Signature: Date: 10-15-18

**Review Key:** "Y" = Complies with LFA requirements "N" = Not approved (complete Section 8)  
 "NA" = Not applicable to the project "NR" = LFA elects not to review

Description	Y	N	NA	NR
1 Where an elevator does not meet medical emergency service cab size, per the California Building Code (CBC), use of stairways for emergency rescue and patient transport is acceptable.				
2 Access roads, fire lane markings, pavers and gate entrances are in accordance with Title 19, California Code of Regulations and the California Fire Code, Chapter 5.				
3 Fire hydrant location and distribution complies with the California Fire Code (or see # 4).				
4 Fire hydrant location and distribution complies with NFPA 1142, "Alternate Means." If "NR" is checked, DSA can only approve on-site water storage as an alternate. The signature of the school district official is required to acknowledge the use of alternate means.				
5 Signature of School District Official: _____ Date: _____				
6 Print the School District Official's Name: _____				
7 The location(s) of the proposed post indicator valve and fire department connection meet the requirements of this jurisdiction.				
8 The location(s) of the detector check valve assembly meet the requirements of this jurisdiction.				
9 Is the project located in a hazard severity zone area? (CBC, Chapter 7A, Section 701A) <input type="checkbox"/> Yes <input checked="" type="checkbox"/> No				
10 Check type if "Yes": <input type="checkbox"/> Moderate <input type="checkbox"/> High <input type="checkbox"/> Very High <input type="checkbox"/> WIFA (If one of these boxes is checked, the project design must meet the requirements of Chapter 7A.)				
11 COMMENTS (note deficiencies):				

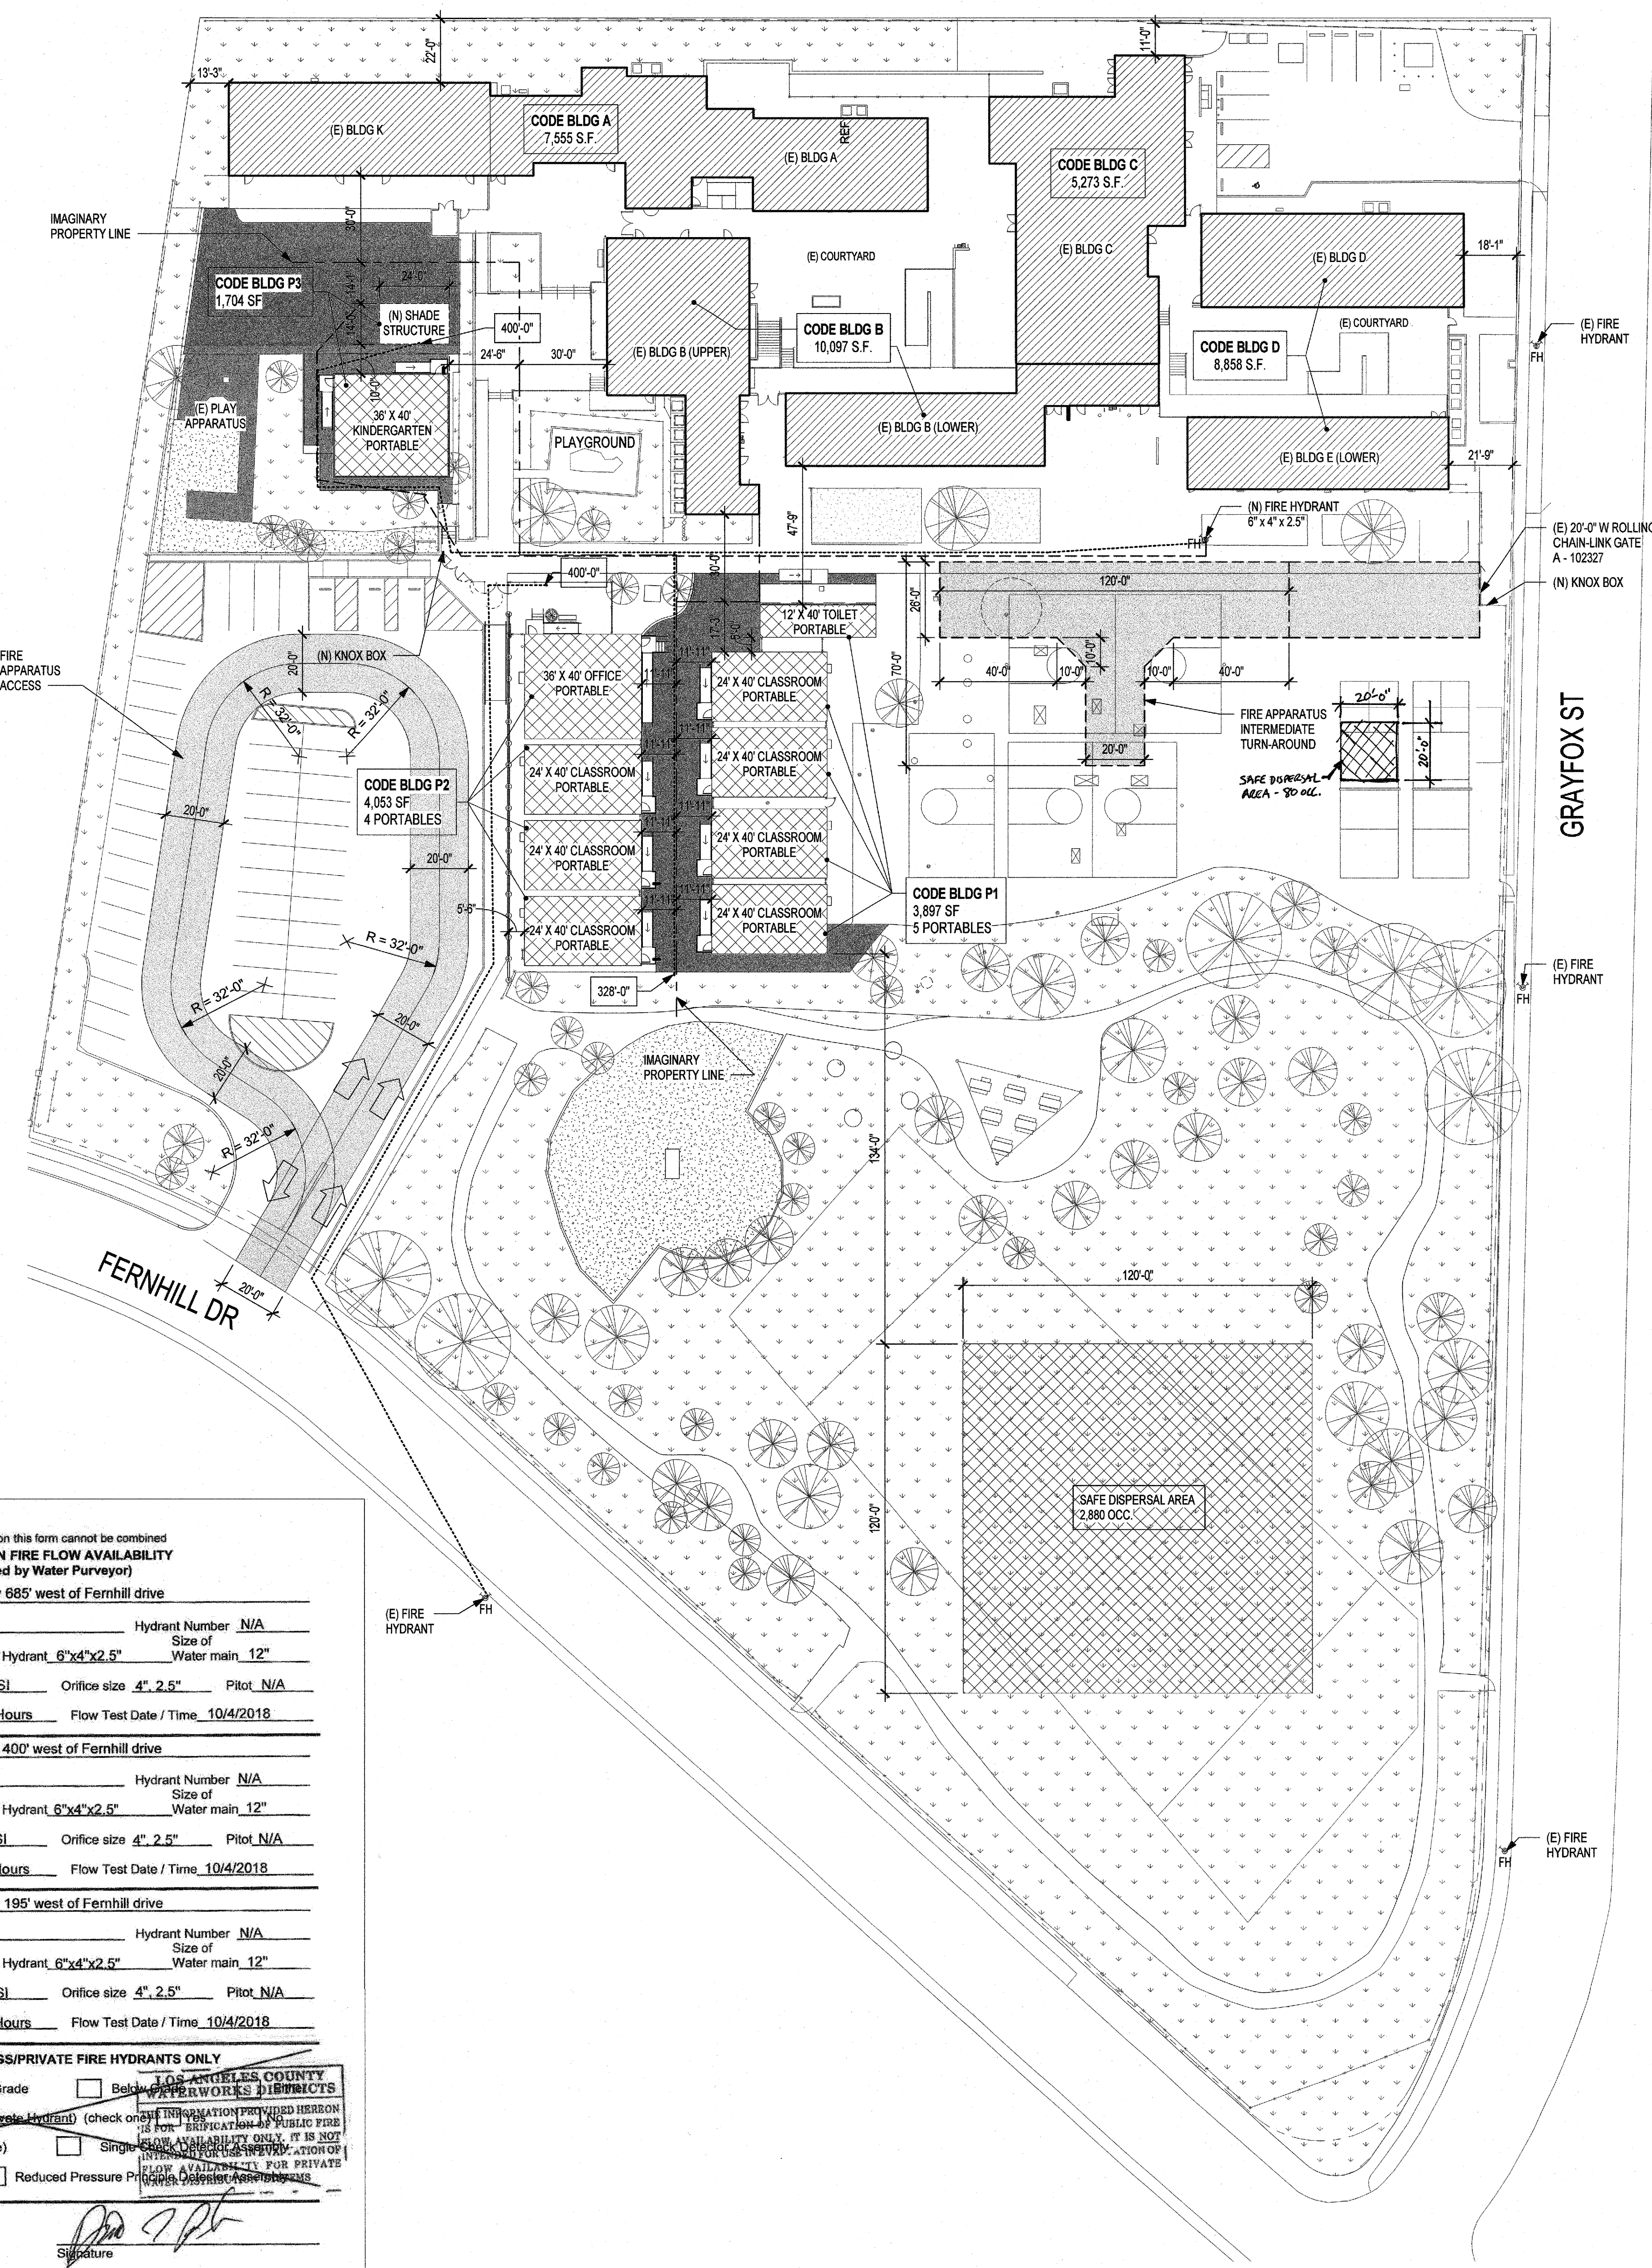

**LEGEND**

- EXISTING BUILDING
- (N) PORTABLE BUILDINGS
- EXISTING LANDSCAPE TO REMAIN
- EXISTING PLANTER TO REMAIN
- EXISTING CHAIN-LINK FENCE TO REMAIN
- EXISTING ORNAMENTAL FENCE TO REMAIN
- FH FIRE HYDRANT
- FIRE HOSE PATH

**SMMUSD**  
 SANTA MONICA-MALIBU UNIFIED SCHOOL DISTRICT  
 2828 4th Street, Santa Monica, CA 90405  
 310.389.5565

**dsk architects**  
 826 Natoma Street, Suite 200, San Francisco, CA 94103  
 415.558.8451 / Fax 415.639.7564

1539 Sawtelle Blvd, Suite 14, Los Angeles, CA 90025  
 310.254.2263

CONSULTANT

**PROJECT NAME**  
 POINT DUME E.S. TEMPORARY HOUSING PROJECT

**FACILITY INFO**  
 POINT DUME ELEMENTARY SCHOOL  
 6955 Fernhill Dr, Malibu, CA 90265

**AGENCY STAMP**

FILE NUMBER: 19-06  
 IDENTIFICATION STAMP  
 DIVISION OF THE STATE ARCHITECT  
 03-116286  
 ACS, PLS, SSS, JF  
 10/15/18

**KEY PLAN**

PROJECT NORTH

**PROJECT ISSUE DATE: 2018/12/20**

DATE	NO.	REVISIONS
2018/12/20		DSA BACKCHECK

**COUNTY OF LOS ANGELES FIRE DEPARTMENT FIRE PREVENTION DIVISION**

Fire Prevention Engineering  
 5823 Rickenbacker Road  
 Commerce, CA 90040  
 Telephone (323) 890-4125 Fax (323) 890-4129

**Information on Fire Flow Availability for Building Permit**

**For All Buildings Other Than Single Family Dwellings (R-3)**

**INSTRUCTIONS:**  
 Complete parts I, II (A) when: Verifying fire flow, fire hydrant location and fire hydrant size.  
 Complete parts I, II (A), & II (B) when: For buildings equipped with fire sprinkler systems, and/or private on-site fire hydrants.

**PROJECT INFORMATION (To Be Completed By Applicant)**

**PART I**  
 Building Address: 6955 Fernhill Drive  
 City or Area: Malibu  
 Nearest Cross Street: Fernhill and Grayfox  
 Distance of Nearest Cross Street: 525 ft (Fire Access is off Grayfox)  
 Applicant: dsk architects Telephone: (310) 254-9771  
 Address: 1539 Sawtelle Blvd.  
 City: Los Angeles, 90025  
 Occupancy (Use of Building): E (School) Sprinklered: Yes  No   
 Type of Construction: 5B (New Portable Buildings)  
 Square Footage: 10,090 Number of Stories: 1  
 Present Zoning: I (Institutional)  
 Applicant's Signature: Date: 08/27/2018

**PART II-A**  
 \*The flows reported on this form cannot be combined  
**INFORMATION ON FIRE FLOW AVAILABILITY**  
 (To be completed by Water Purveyor)

Location: Along Grayfox Street, approximately 685' west of Fernhill drive

Distance from Nearest Property Line: 0' (fronting) Size of Hydrant: 6"x4"x2.5" Water main: 12"  
 Static PSI: 96 Residual PSI: 20 PSI Orifice size: 4", 2.5" Pitot: N/A  
 Fire Flow at 20 PSI: 1,750 gpm\* Duration: 2 Hours Flow Test Date / Time: 10/4/2018

Location: Along Grayfox Street, approximately 400' west of Fernhill drive

Distance from Nearest Property Line: 0' (fronting) Size of Hydrant: 6"x4"x2.5" Water main: 12"  
 Static PSI: 98 Residual PSI: 20 PSI Orifice size: 4", 2.5" Pitot: N/A  
 Fire Flow at 20 PSI: 1,750 gpm\* Duration: 2 Hours Flow Test Date / Time: 10/4/2018

Location: Along Grayfox Street, approximately 195' west of Fernhill drive

Distance from Nearest Property Line: 0' (fronting) Size of Hydrant: 6"x4"x2.5" Water main: 12"  
 Static PSI: 98 Residual PSI: 20 PSI Orifice size: 4", 2.5" Pitot: N/A  
 Fire Flow at 20 PSI: 1,750 gpm\* Duration: 2 Hours Flow Test Date / Time: 10/4/2018


**PART II-B**  
**SPRINKLERED BUILDINGS/PRIVATE FIRE HYDRANTS ONLY**

Detector Location (check one)  Above Grade  Below Grade  
 Backflow Protection Required (Fire Sprinklers/Private Hydrant) (check one)  Single Check Valve  Reduced Pressure Backflow Preventer  
 Minimum Type of Protection Required (check one)  Single Check Valve  Reduced Pressure Backflow Preventer  
 Double Check Detector Assembly  Reduced Pressure Backflow Preventer

L.A. Co. Waterworks District # 29  
 Water Purveyor Signature: Date: 10/9/2018  
 Title: David Hydman, Senior Civil Engineer

**This Information is Considered Valid for Twelve Months**

Fire Department approval of building plans shall be required prior to the issuance of a Building Permit by the jurisdictional Building Department. Any deficiencies in water systems will be resolved by the Fire Prevention Division prior to this department's approval of building plans.

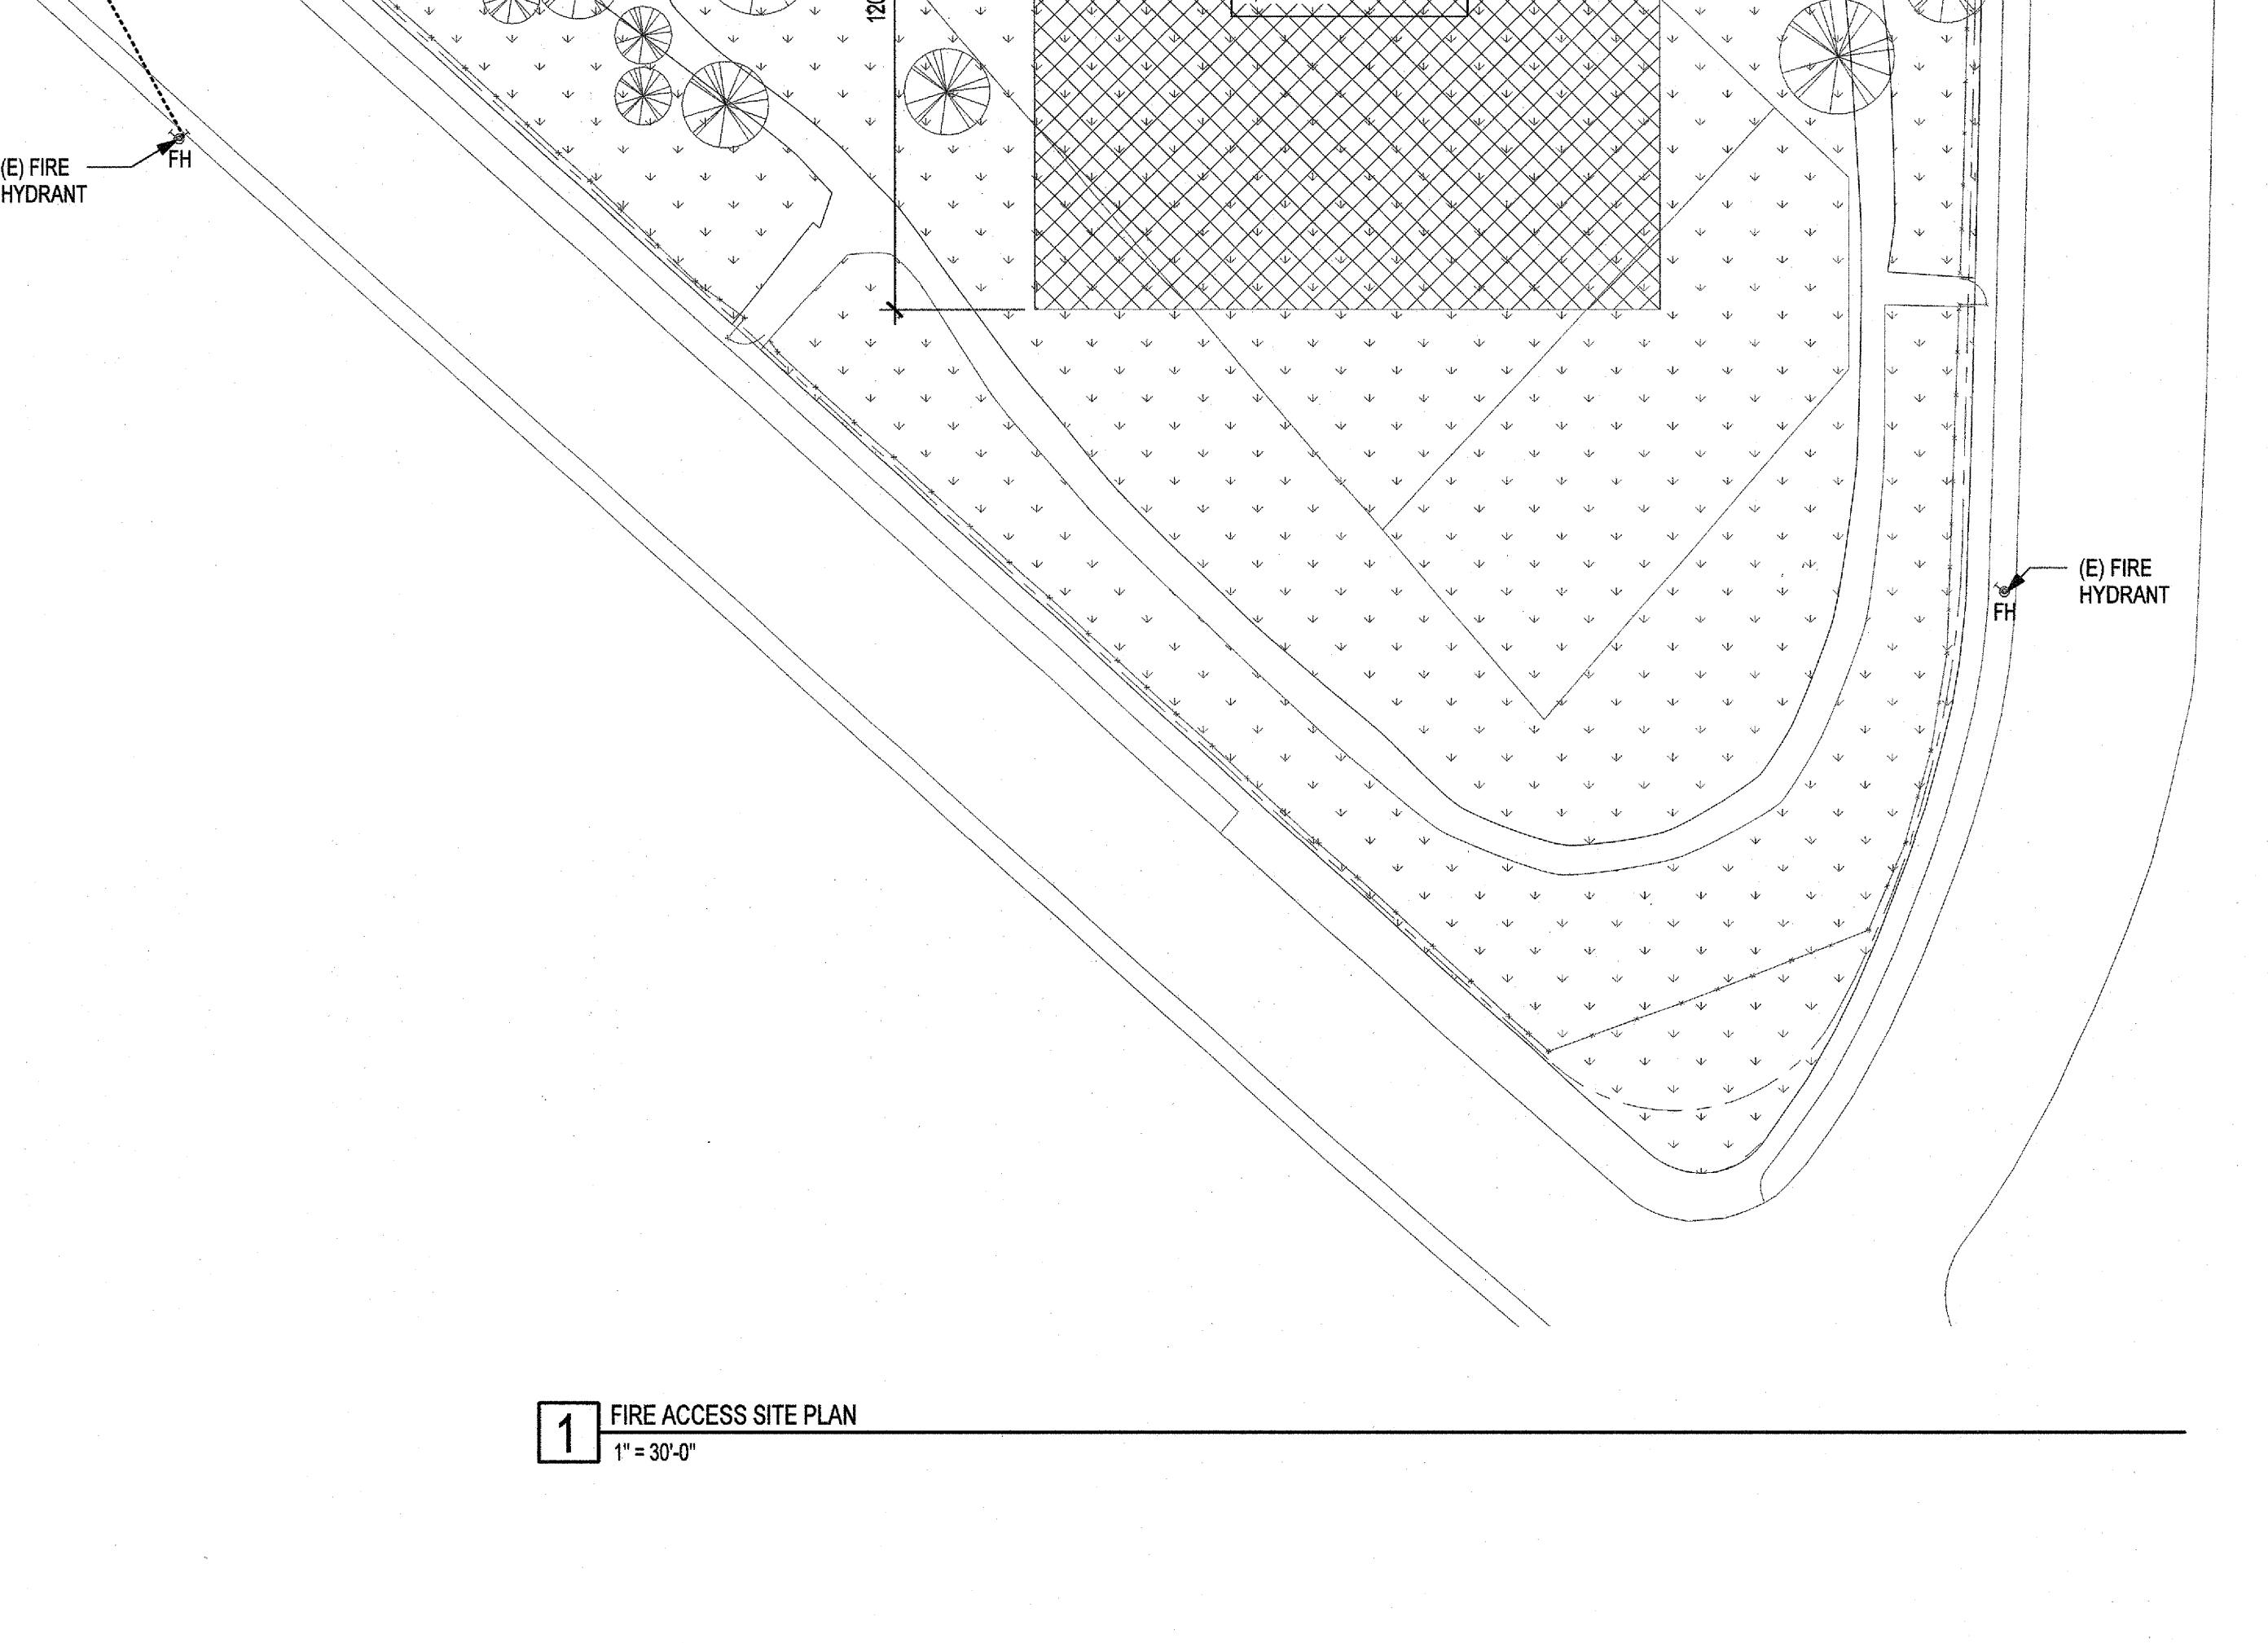

**COUNTY OF LOS ANGELES FIRE DEPARTMENT FIRE PREVENTION ENGINEERING**

**APPROVED**

FOR E/B OCCUPANCY ONLY

By: [Signature] Fire Prevention Engineer  
 Date: 10-15-18

Subject to field inspection approval.  
 Subject to conditions on plans.


The stamping of this plan and seal indicates that the Fire Prevention Engineer has approved the fire flow and hydrant information shown on this plan. It does not constitute an approval of the violation of any provisions of any County/City Ordinance or State Law.

SHEET TITLE: FIRE ACCESS SITE PLAN  
 SHEET NUMBER: A0.02  
 DRAFTER: JL  
 PM: JL  
 REVIEWER: JF

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PROJECT ISSUE DATE: 2018/12/20

DATE	NO.	REVISIONS
2018/12/20		DSA BACKCHECK

**KEYNOTE LEGEND**

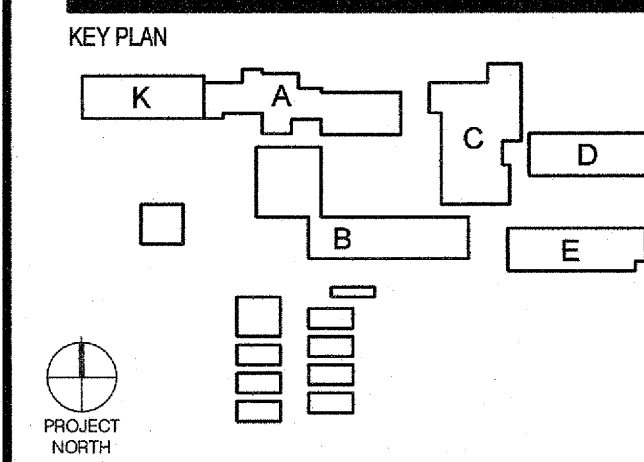
- A.16 EXISTING MARQUEE SCHOOL SIGN TO REMAIN.
- A.19 SAW CUT AND REMOVE PORTION OF EXISTING SIDEWALK AS SHOWN.
- A.35 REMOVE EXISTING BENCH AND RETURN TO DISTRICT.
- A.36 PROTECT EXISTING FLAGPOLE IN PLACE.
- A.39 REMOVE EXISTING BIKE RACKS AND RETURN TO DISTRICT.
- A.40 REMOVE (E) ASPHALT/CONC. CURB, CONC. DRIVEWAY & GRASS PLANTINGS AS REQ'D TO ENLARGE EXISTING DRIVEWAY ACCESS. SEE SITE PLAN.
- L.03 PRUNE EXISTING TREE AS REQUIRED FOR ADJACENT WORK.

**LEGEND**


- EXISTING BUILDING - AREA OF WORK
- NEW PORTABLE BUILDING
- EXISTING BUILDING - NOT IN SCOPE
- EXISTING LANDSCAPE TO REMAIN
- EXISTING PLANTER TO REMAIN
- EXISTING CHAIN-LINK FENCE TO REMAIN
- EXISTING ORNAMENTAL FENCE TO REMAIN
- REMOVE EXISTING CHAIN-LINK FENCE
- REMOVE EXISTING ORNAMENTAL FENCE
- (E) FH EXISTING FIRE HYDRANT TO REMAIN
- PATH OF TRAVEL (P.O.T.)
- ACCESSIBLE RESTROOM
- ACCESSIBLE DRINKING FOUNTAIN

**GENERAL NOTES**

1. KEYNOTES ARE TYPICAL UNLESS OTHERWISE NOTED.
2. PROTECT ALL TREES IN PLACE UNLESS OTHERWISE NOTED.
3. BRING ANY GRATES, CLEAN-OUTS, ACCESS PANELS, UTILITIES, OR OTHER IN-GROUND CONDITIONS NOT IDENTIFIED ON THE ARCHITECTURAL OR CIVIL DRAWINGS TO THE ATTENTION OF THE DESIGN TEAM IMMEDIATELY. DO NOT REMOVE OR COVER UNTIL DIRECTED.
4. FOR CDP REVIEWER: PROJECT DOES NOT INCLUDE DEMOLITION/REPLACEMENT OF ANY EXISTING EXTERIOR WALLS.

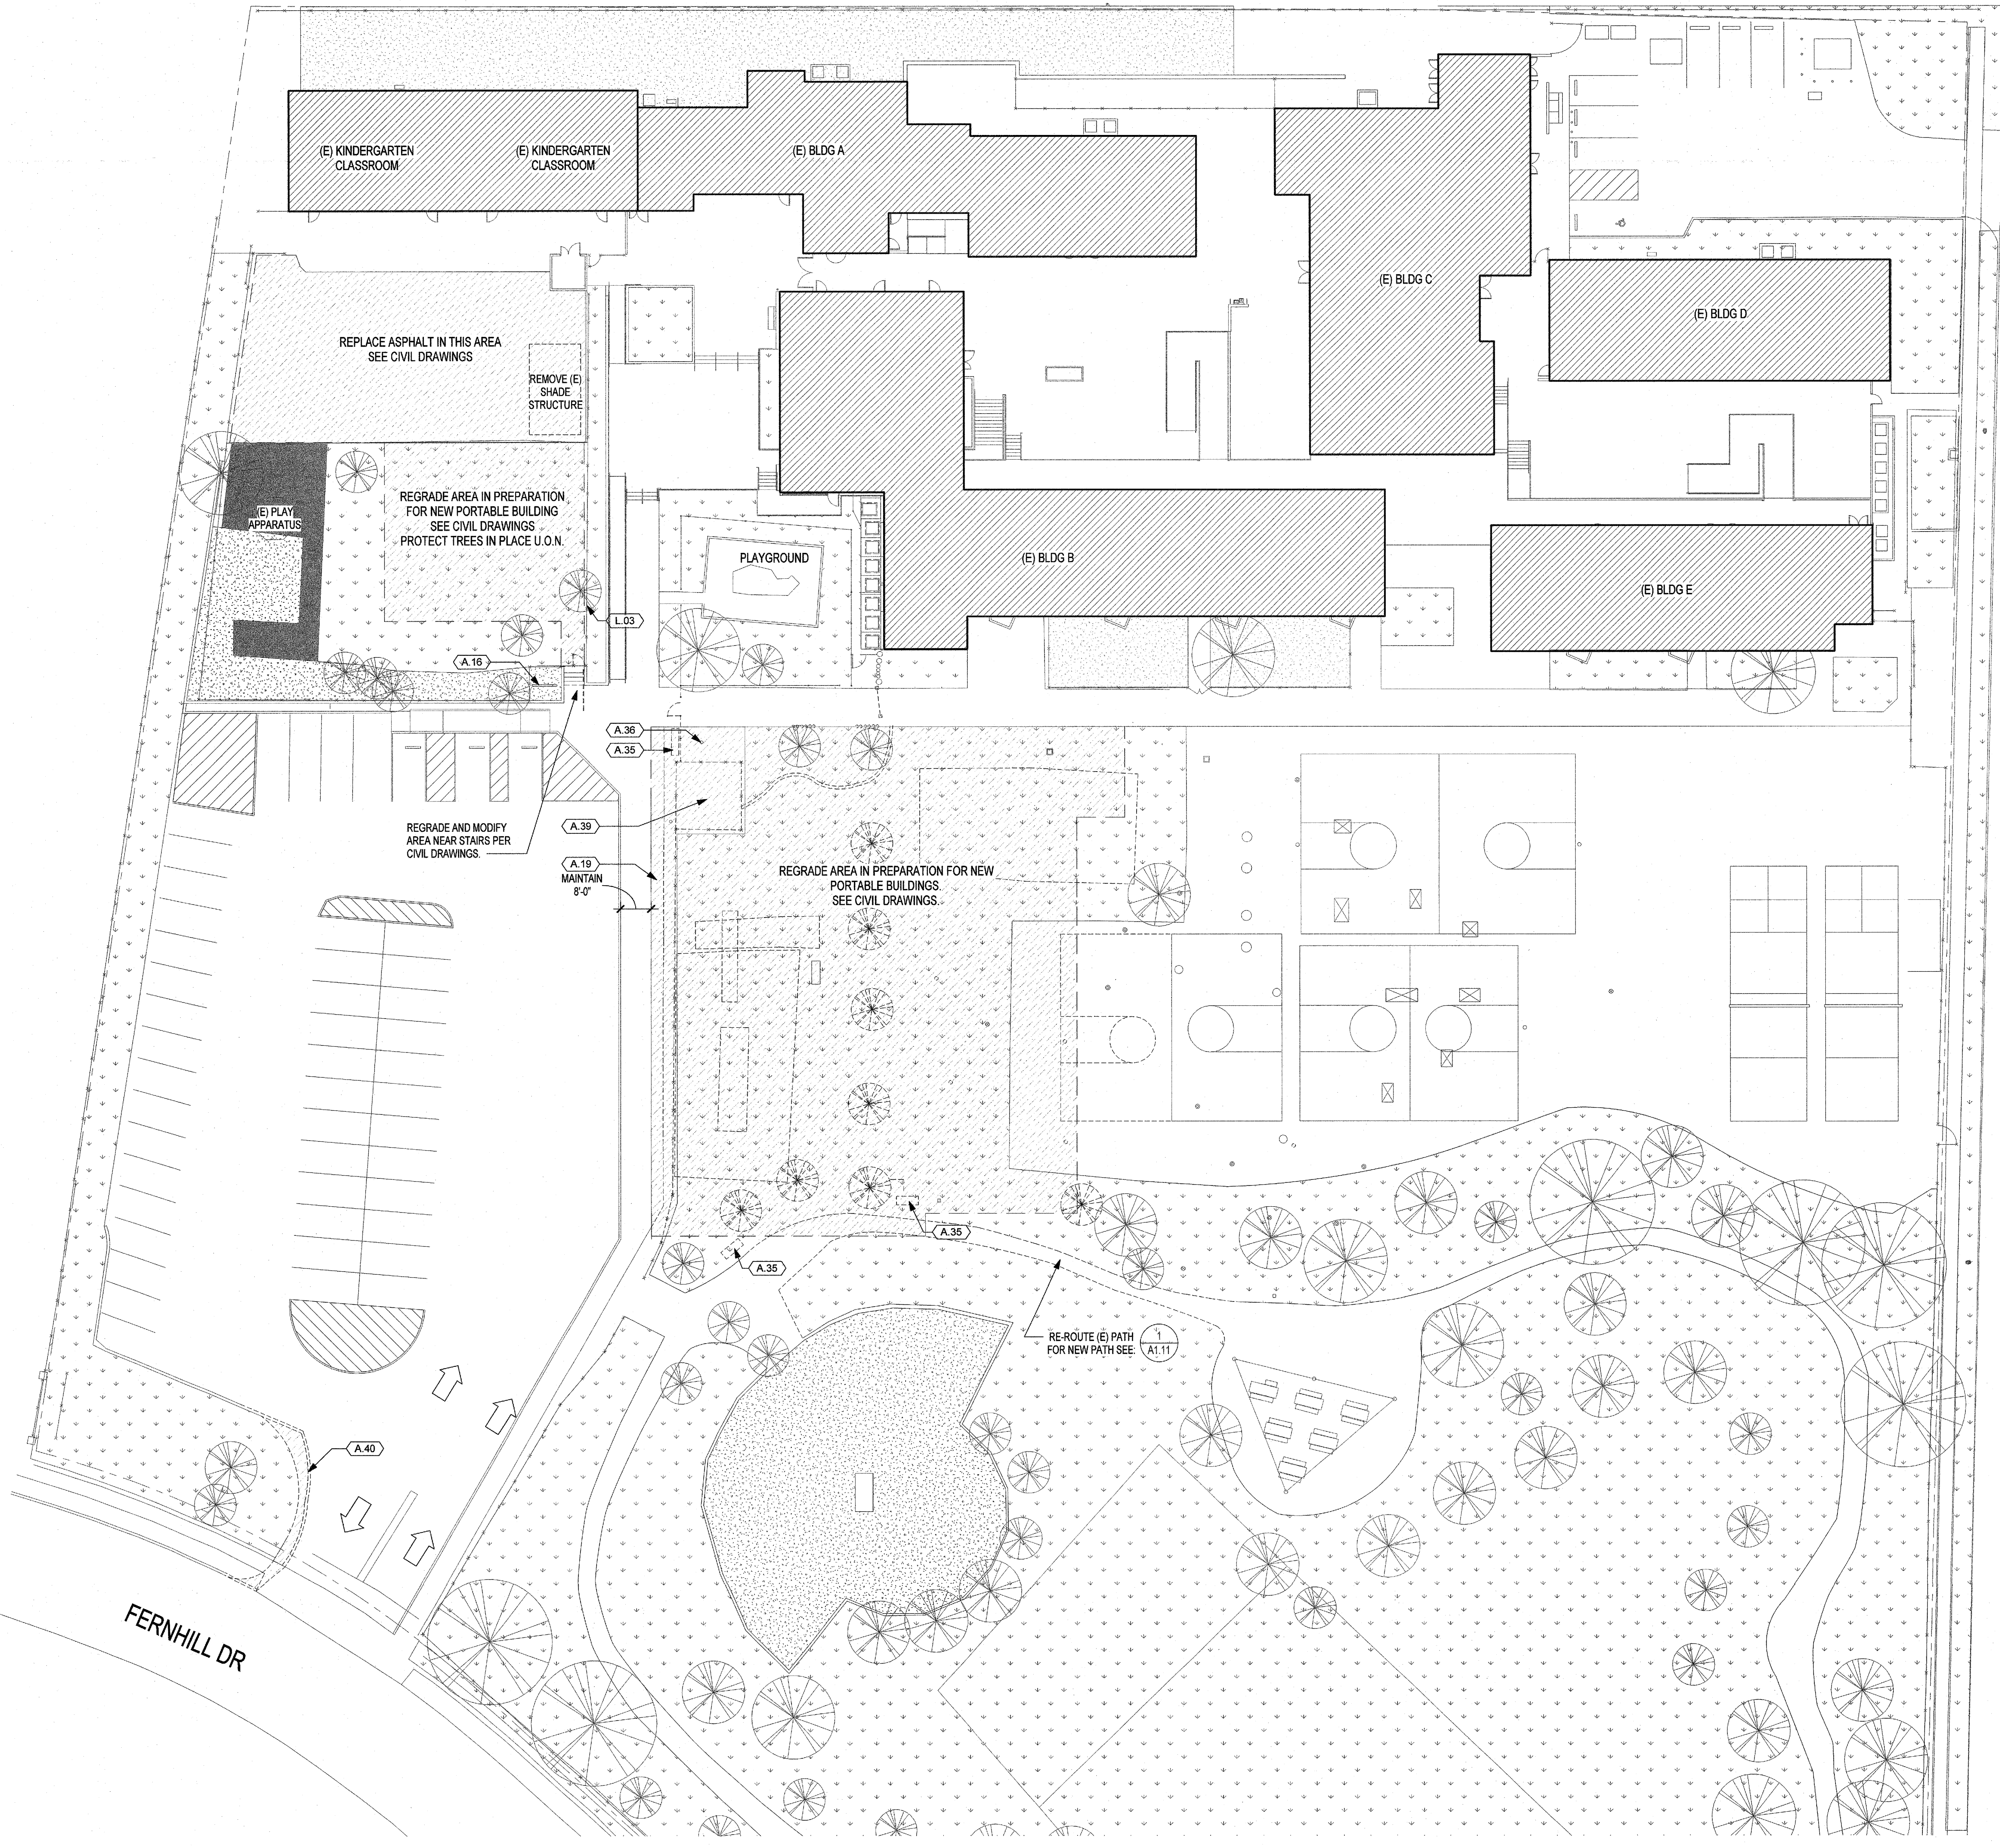


GRAYFOX ST

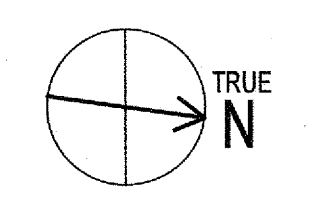

1 DEMO SITE PLAN  
 1" = 20'-0"

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1 SITE PLAN  
1" = 20'-0"

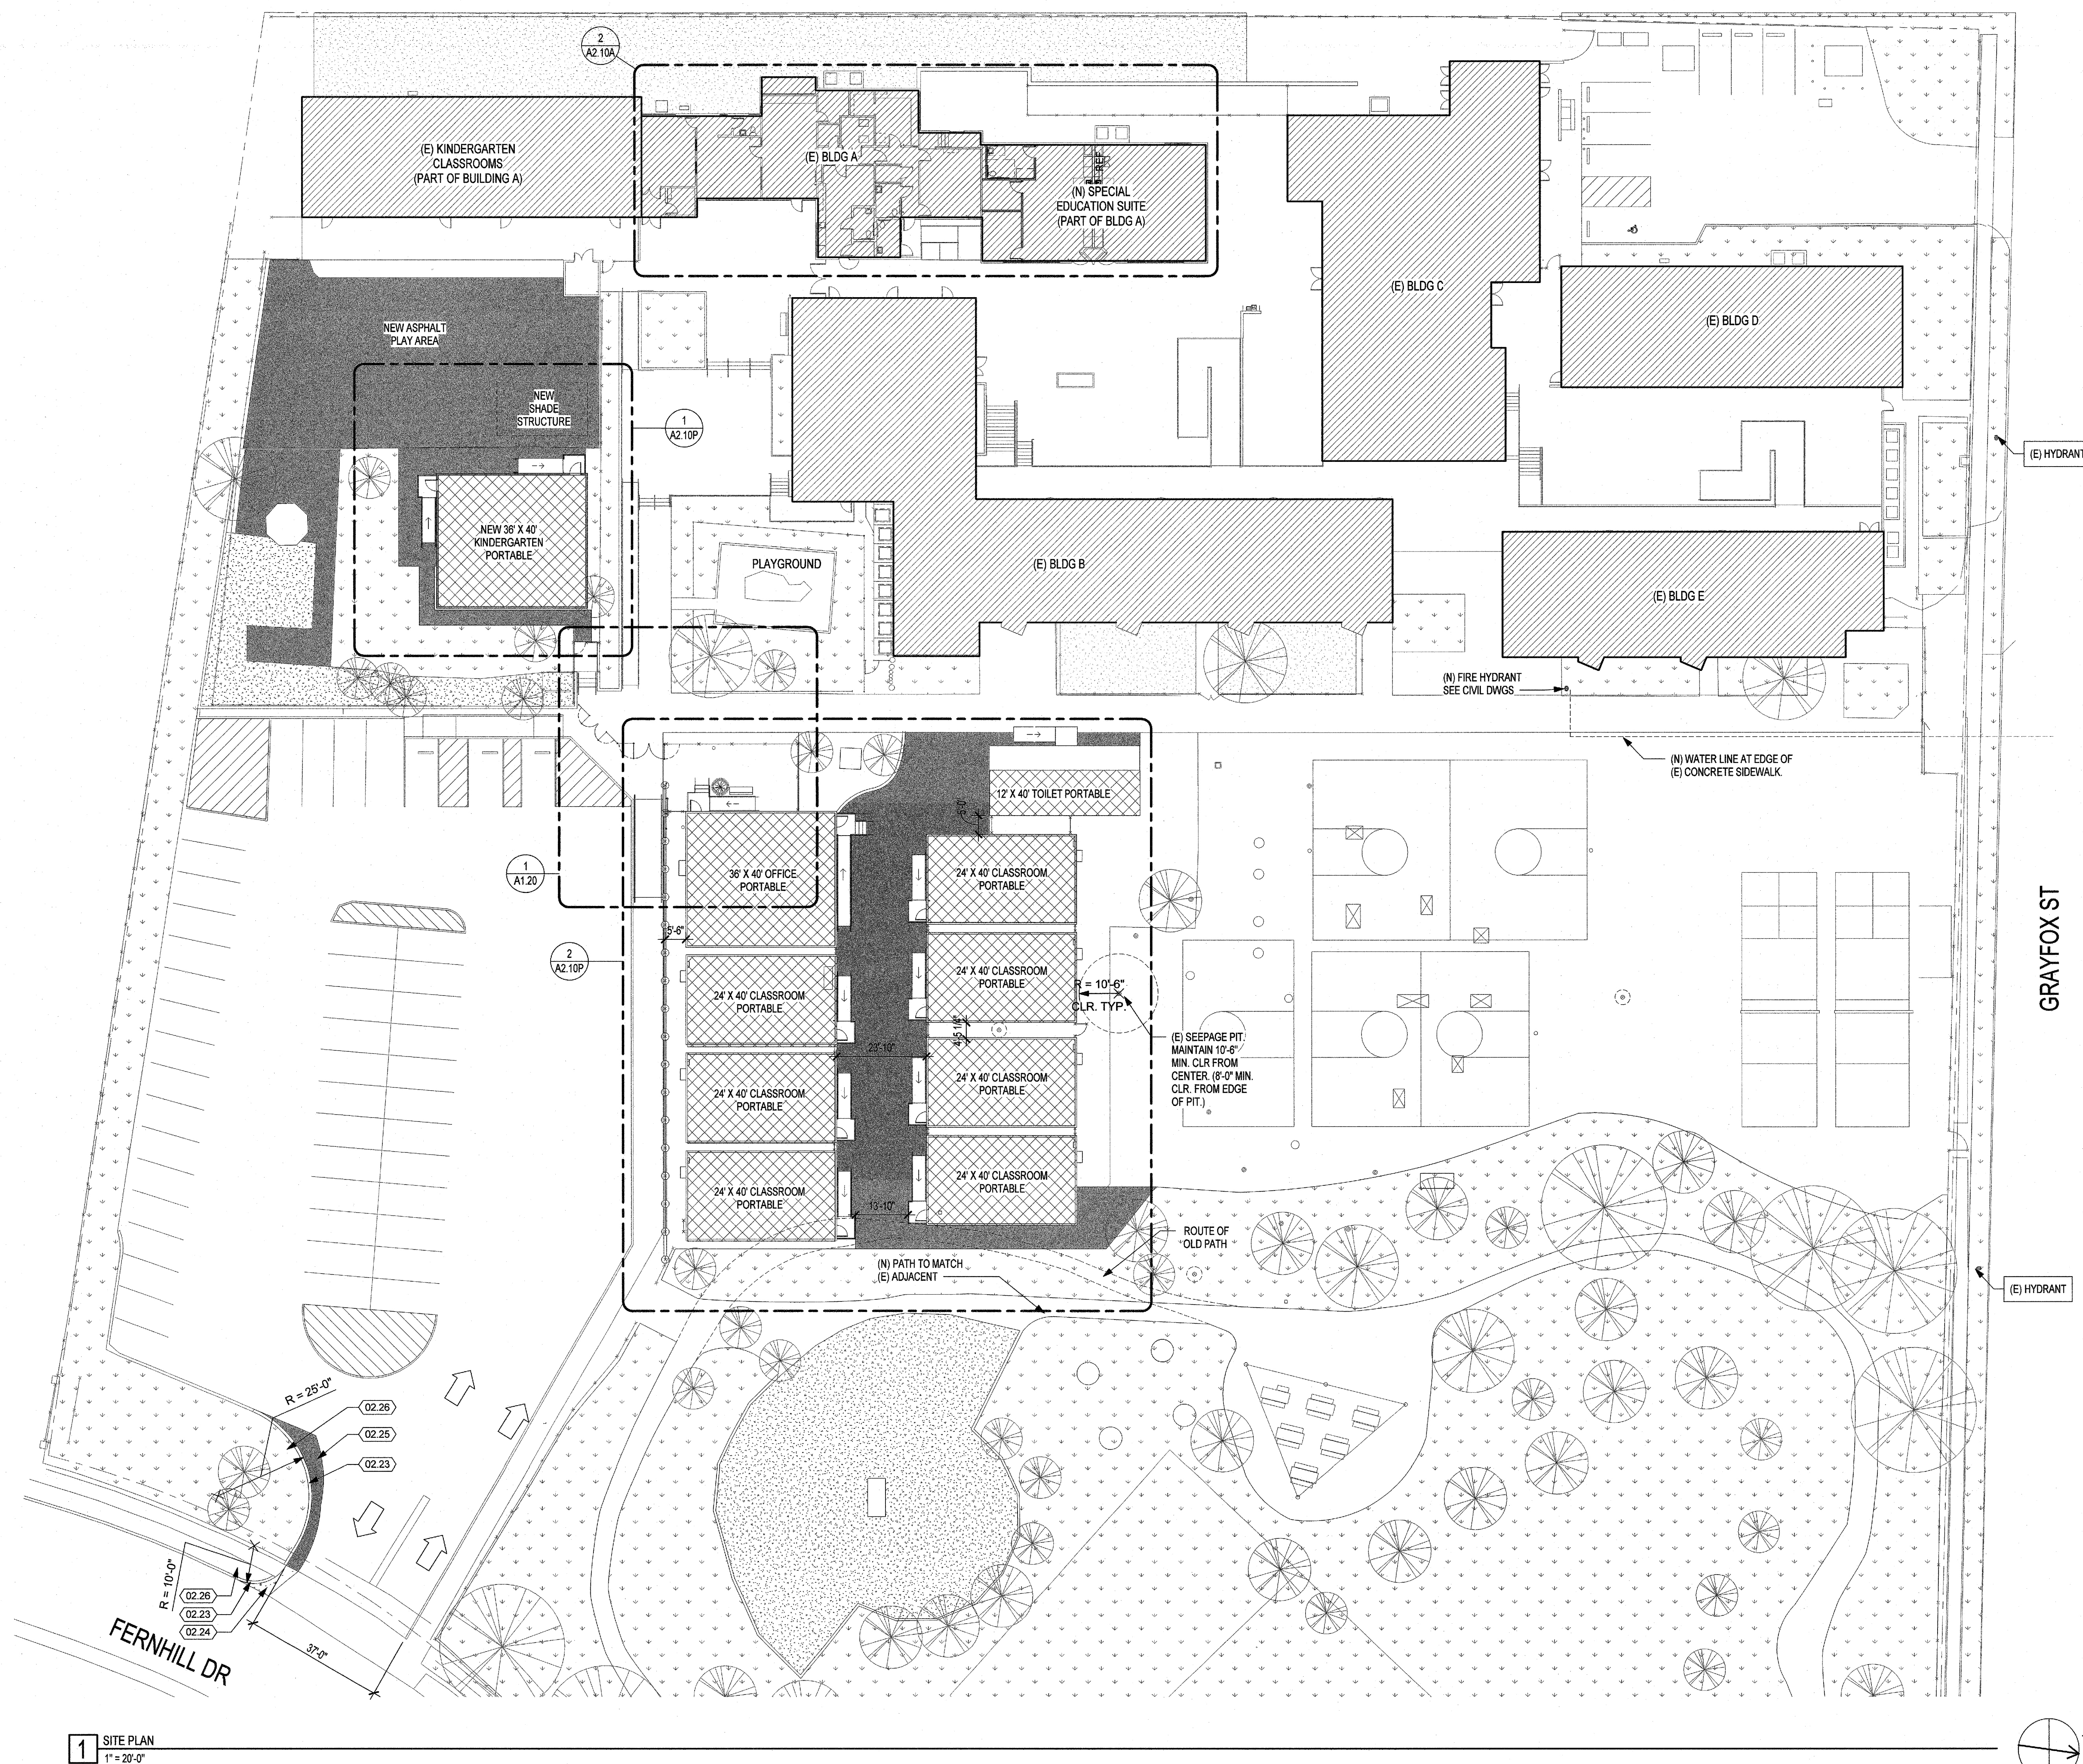**LEGEND**


- EXISTING BUILDING - AREA OF WORK
- NEW PORTABLE BUILDING
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- REMOVE EXISTING ORNAMENTAL FENCE
- (E) FH EXISTING FIRE HYDRANT TO REMAIN
- PATH OF TRAVEL (P.O.T.)
- ACCESSIBLE RESTROOM
- ACCESSIBLE DRINKING FOUNTAIN

**GENERAL NOTES**

1. ALL KEYNOTES ARE TYPICAL UNLESS OTHERWISE NOTED.
2. CONTRACTOR IS RESPONSIBLE TO PATCH AND REPAIR ALL WALLS AND FLOORING DAMAGED DURING DEMOLITION IN SCOPE OF WORK.
3. CONCRETE PAD SIZES TO BE VERIFIED IN FIELD.
4. PORTABLE BUILDINGS WILL BE PROCURED AND INSTALLED BY THE DISTRICT UNDER A SEPARATE CONTRACT. G.C. TO PROVIDE SITE WORK, FENCES, UTILITIES, CONNECTIONS, AND EXTERIOR LIGHTING.

**KEYNOTES**




- 02.23 NEW CONCRETE CURB, PROVIDE SMOOTH TRANSITION TO EXISTING CURB. SEE CIVIL.
- 02.24 PATCH CONC. DRIVEWAY/SIDEWALK AS REQ'D TO MATCH EXISTING. SEE CIVIL.
- 02.25 PATCH ASPHALT AS REQ'D TO MATCH EXISTING. SEE CIVIL.
- 02.26 PATCH SOD AS REQ'D TO MATCH EXISTING. SEE CIVIL.

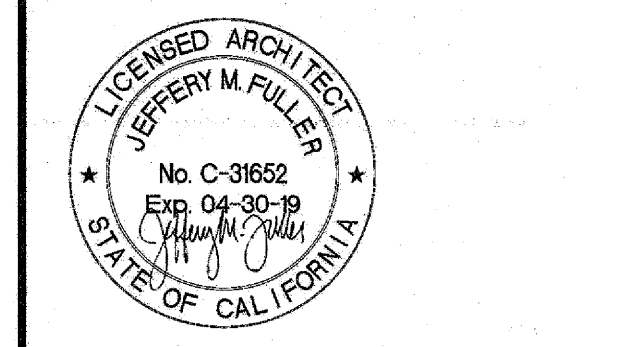

CONSULTANT

**PROJECT NAME**  
 POINT DUME E.S.  
 TEMPORARY HOUSING  
 PROJECT

**FACILITY INFO**  
 POINT DUME ELEMENTARY SCHOOL  
 6985 Fernhill Dr., Malibu, CA 90265  
 AGENCY STAMP

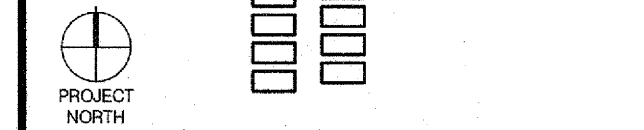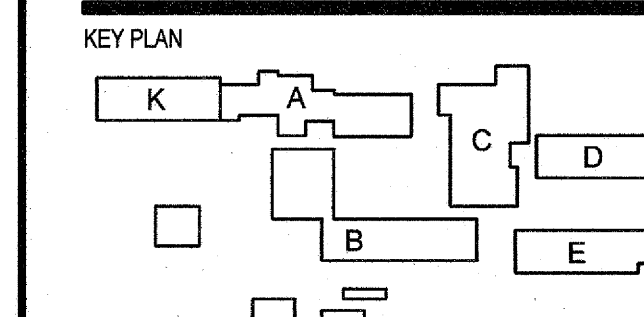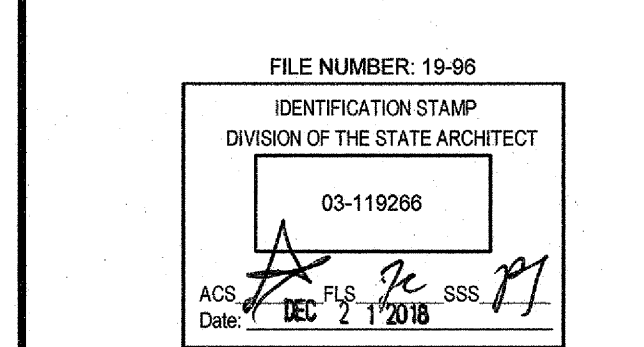

**PROJECT ISSUE DATE: 2018/12/20**

DATE	NO.	REVISIONS
2018/12/20	01	DSA BACKCHECK

SHEET TITLE: **SITE PLAN**  
 DSK JOB NO.: 170126

SHEET NUMBER: **A1.11**  
 DRAFTER: JHUL PM: JL REVIEWER: JF







PROJECT ISSUE DATE: 2018/12/20

DATE	NO.	REVISIONS
2018/12/20		DSA BACKCHECK

**FINISH NOTES**

- DO NOT PAINT UNFINISHED / NATURAL FINISH WOOD U.O.N. PROTECT AND PRESERVE IN PLACE.
- DO NOT PAINT LAMINATE MATERIAL. PROTECT AND PRESERVE IN PLACE.
- ALL INTERIOR WALLS, SOFFITS, PREVIOUSLY PAINTED WOODEN TRIM AND TACKLE SURFACES ARE TO RECEIVE PT-1, U.O.N.
- CHECKERBOARD MIX LINOLEUM COMPOSITE TILE (LCT) FROM DIFFERENT BOXES IN SPACES WHERE ONE BOX IS NOT SUFFICIENT TO COVER THE ENTIRE FLOOR.
- LCT TO BE INSTALLED IN A QUARTER-TURNED PATTERN, (TURNED WITH GRAIN PATTERN 90 DEGREES FROM ADJACENT TILES).
- BEGIN LCT INSTALLATION FROM THE CENTER OF THE TILED AREA. SHIFT PATTERN IF NEEDED TO AVOID NARROW "SLIVERS" OF TILE AT CARPET TRANSITION EDGES.
- INFORM ARCHITECT OF ANY CONFLICT OR OVERSIGHT REGARDING FINISHES.
- REFER TO SPECIFICATIONS TO SELECT INTERIOR PAINT APPROPRIATE TO EXPOSED SURFACES TO BE PAINTED.

**FINISH LEGEND**

MARK	MATERIAL	MFG.	PRODUCT LINE	COLOR	FINISH	PRODUCT #	LOCATION
PT-1	PAINT	PPG	CUSTOM	SMUSD WHITE	SEMI-GLOSS	--	CLASSROOM WALL & CW
CT-1	CER. TILE	DALTILE	KEYSTONE	SUEDE GRAY (D182)	UNGLAZED	--	BATHROOM FLOORS
CT-2	CWB	DALTILE	KEYSTONE	SUEDE GRAY (D182)	UNGLAZED	C-833	BASE OF BATHROOM WALLS
CT-3	CER. TILE	DALTILE	KEYSTONE	DESERT GRAY (D014)	MATTE	--	BATHROOM WALLS
LCT-1	LIN. TILE	FORBO	MARMOLEUM TILE	BLUE	--	MCT-3030	CLASSROOM FLOORS
WB-1	WALL BASE	FORBO	6" RUBBER WALL BASE	BLACK	--	--	WALL BASE

\*OR APPROVED EQUAL, PRODUCT AND COLOR TO BE APPROVED BY ARCHITECT

**KEYNOTE LEGEND**

06.01	NEW CASEWORK, SEE ELEVATIONS.	16.05	NEW PENDANT LIGHT FIXTURE, S.E.D.
09.12	(N) CERAMIC WALL TILE ON (E) GYP. BD. ON WD STUD WALL.	B.01	REMOVE EXISTING FLOORING MATERIAL & WALL BASE. PREPARE SURFACE TO RECEIVE NEW FINISH. SEE FINISH PLANS.
09.15	FURRING WALL - 5/8" GYP. BD. ON 2x4 WD STUDS @ 16" O.C. - ON CONC CURB, SEE DETAIL 11/A2.10A	B.02	REMOVE EXISTING WALL BASE. PREPARE SURFACE TO RECEIVE NEW FINISH.
09.19	WOOD STUD & GYPSUM BOARD PARTITION, 2x4 STUDS @ 18" O.C., SEE 11/A2.10A FOR BASE (TOILET ROOM ONLY), AND 10/A2.21 FOR TOP.	B.04	SAWCUT (E) CONCRETE SLAB AS REQ'D TO INSTALL (N) PLUMBING, COORDINATE W/PLUMBING DWGS. PATCH AS REQ'D TO MATCH EXIST.
09.29	PATCH GLUE-ON CEILING TILES @ REMOVED CASEWORK.	B.06	(E) LINOLEUM TILE FLOORING & RUBBER BASE TO REMAIN, U.O.N.
09.32	(N) 1/2" GYP. BD. CEILING ON (E) 2X ROOF JOISTS. CEILING TO SLOPE TO FOLLOW (E) ROOF JOIST SLOPE.	C.06	CUT & REMOVE (E) PARTITION WALL FOR (N) WINDOW. SEE FLOOR PLAN & WINDOW SCHEDULE.
09.36	PATCH LINOLEUM COMPOSITE TILE AT REMOVED CASEWORK TO MATCH EXISTING FLOORING.	C.07	CUT & REMOVE (E) PARTITION WALL AT PREVIOUSLY INFILLED OPENING FOR (N) DOOR, CENTER (N) DOOR ON (E) PREVIOUSLY INFILLED OPENING. REMOVE (E) WOOD TRIM AROUND (E) INFILLED OPENING.
09.37	PATCH & PAINT (E) GYP. BD. WALL AT REMOVED CASEWORK.	D.01	EXISTING CEILING SYSTEM TO REMAIN.
09.38	(N) 5/8" GYP. BD. ON (E) 2X FRAMING @ HEATER CLOSET TO MATCH EXIST, PAINT PT-1.	D.03	CUT AND REMOVE (E) GLUE-ON TILE CEILING & SUBSTRATE AT NEW ROOMS, SEE FLOOR PLAN. (E) ROOF JOISTS TO REMAIN.
10.06	MIRROR.	H.04	REMOVE EXISTING CASEWORK, COUNTERTOP AND ALL ASSOCIATED ACCESSORIES.
10.07	GRAB BAR.	M.02	REMOVE LAVATORY AND PREPARE PLUMBING FOR NEW LAVATORY - COORDINATE WITH PLUMBING DWGS.
10.16	EXISTING FIRE EXTINGUISHER TO REMAIN.	N.01	REMOVE EXISTING LIGHT FIXTURES.
12.01	PORTABLE CHANGING TABLE CART BY OWNER (N.I.C.)	N.02	RELOCATE & REINSTALL EXISTING LIGHT FIXTURES, SEE FLOOR PLAN AND ELEC. DWGS.
12.02	REFRIGERATOR BY OWNER (N.I.C.)	N.05	EXISTING LIGHT FIXTURES TO REMAIN, TYP.
15.01	TOILET, SEE PLUMBING DWGS		
15.02	LAVATORY, SEE PLUMBING DWGS		
15.12	(N) EXHAUST FAN UP TO ROOF, S.M.D. PATCH ROOF AS REQ'D TO MATCH EXISTING.		
16.04	NEW SURFACE MOUNTED LIGHT FIXTURE, S.E.D.		


**GENERAL NOTES**

- CONTRACTOR IS RESPONSIBLE TO PATCH AND REPAIR ALL WALLS, CEILING, AND FLOORING DAMAGED DURING DEMOLITION WORK.
- ALL KEYNOTES ARE TYPICAL UNLESS OTHERWISE NOTED.
- PRESERVE AND PROTECT ALL ITEMS NOT IN SCOPE OF WORK.
- ALL DIMENSIONS ARE TO BE VERIFIED IN FIELD.
- ALL SCREWS CONNECTING THROUGH DISSIMILAR METALS (STOREFRONT TO STEEL, FLASHING TO STEEL, ECT.) ARE TO BE STAINLESS STEEL.
- CENTER LIGHT FIXTURES WITHIN SPACES, U.O.N.
- APPLY LOW EXPANSION SPRAY FOAM BETWEEN SHIM AT ROUGH OPENING FOR WINDOW AND DOORS.
- EXISTING ROLLING SHADE SYSTEM TO BE REMOVED, WHERE REQ'D FOR NEW CONSTRUCTION, AND REINSTALLED BY OTHERS.
- CONTRACTOR TO PROTECT CEILING AND CEILING TILES TO REMAIN DURING WORK. THIS INCLUDES DAMAGED CAUSED BY ADHESIVES APPLIED TO TILE.
- ALL GYP. BD. IN TOILET ROOMS ARE TO BE MOISTURE RESISTANT.
- FOR ACCESSIBLE MOUNTING HEIGHTS, SEE DETAIL 1/A9.51
- FOR BLOCKING DETAILS, SEE DETAILS 10/A2.10A, 12/A2.10A, 13/A2.10A


**LEGEND**

- EXISTING PARTITIONWALL
- NEW PARTITIONWALL
- REMOVE EXISTING ITEMS / PARTITION / WALL
- REMOVE EXISTING FINISH FLOOR / WALL / CEILING FINISH
- PATCH FLOOR W/ (N) CONC SLAB & LCT-1 FLOORING TO MATCH EXISTING
- EXISTING DOOR TO REMAIN
- EXISTING DOOR TO BE REMOVED
- NEW DOOR, SEE DOOR SCHEDULE
- DOOR TAG
- NEW WINDOW


**14** SLAB PATCHING DETAIL  
 1 1/2" = 1'-0"

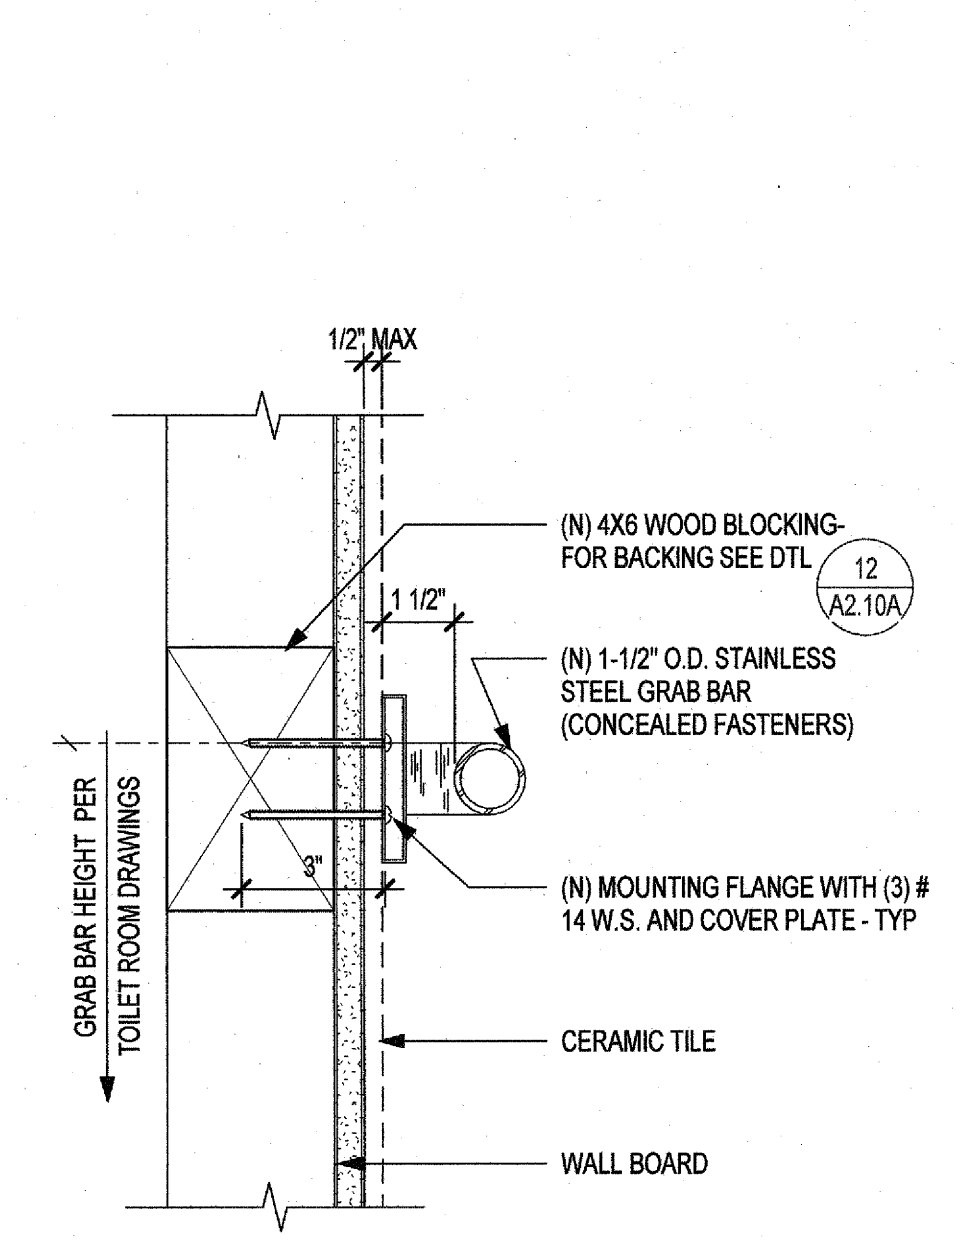


**13** GRAB BAR WOOD BLOCKING  
 3" = 1'-0"

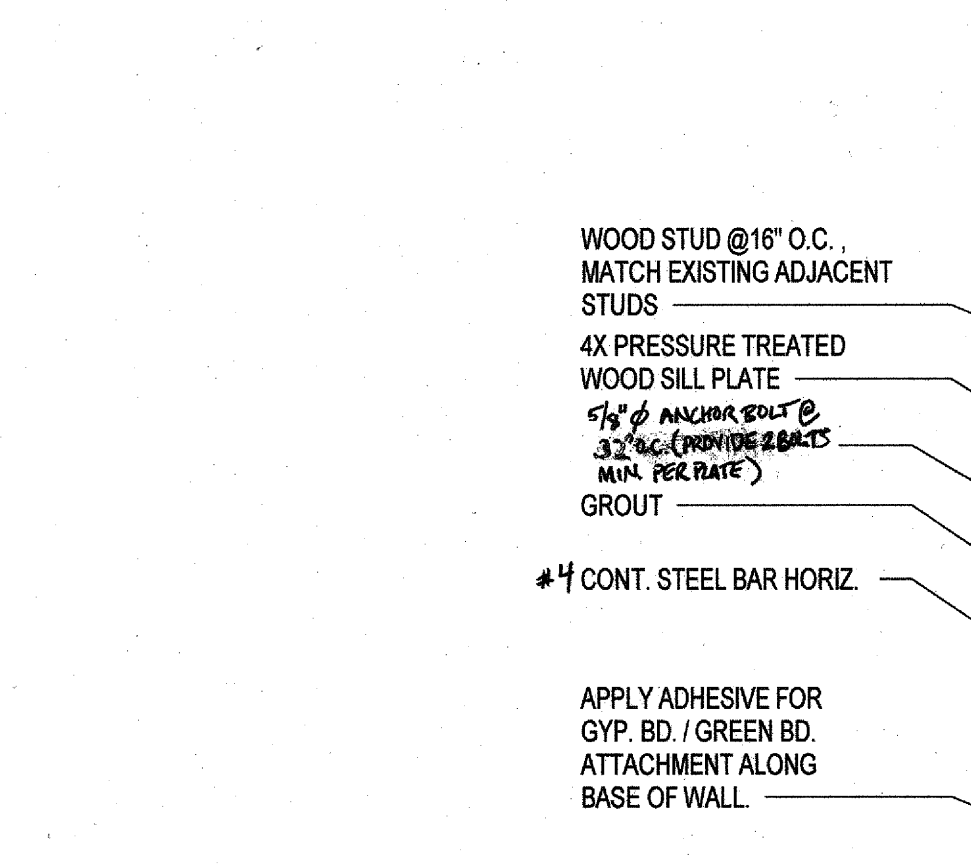

**12** TYPICAL WOOD BLOCKING DETAIL  
 1 1/2" = 1'-0"

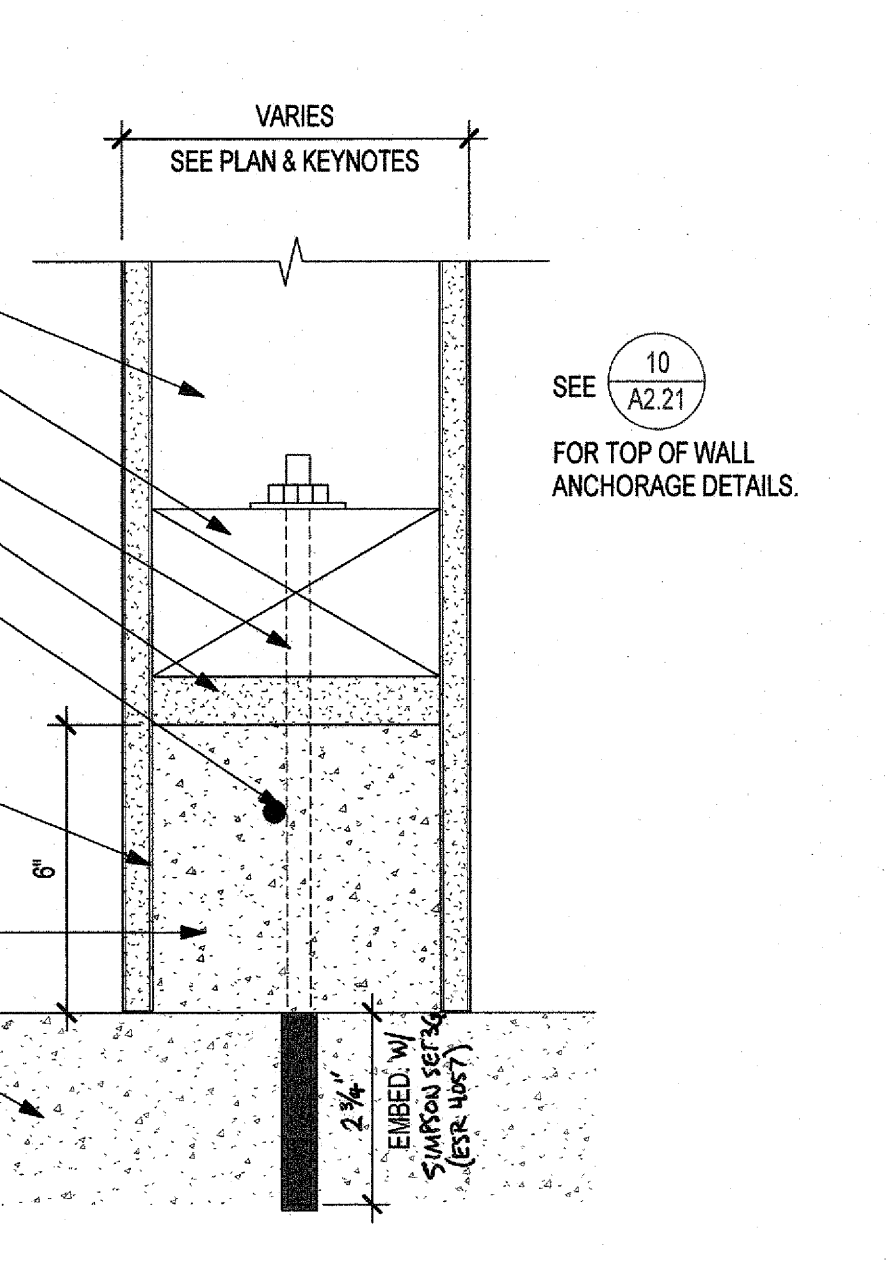


**11** WALL CURB DETAIL  
 3" = 1'-0"

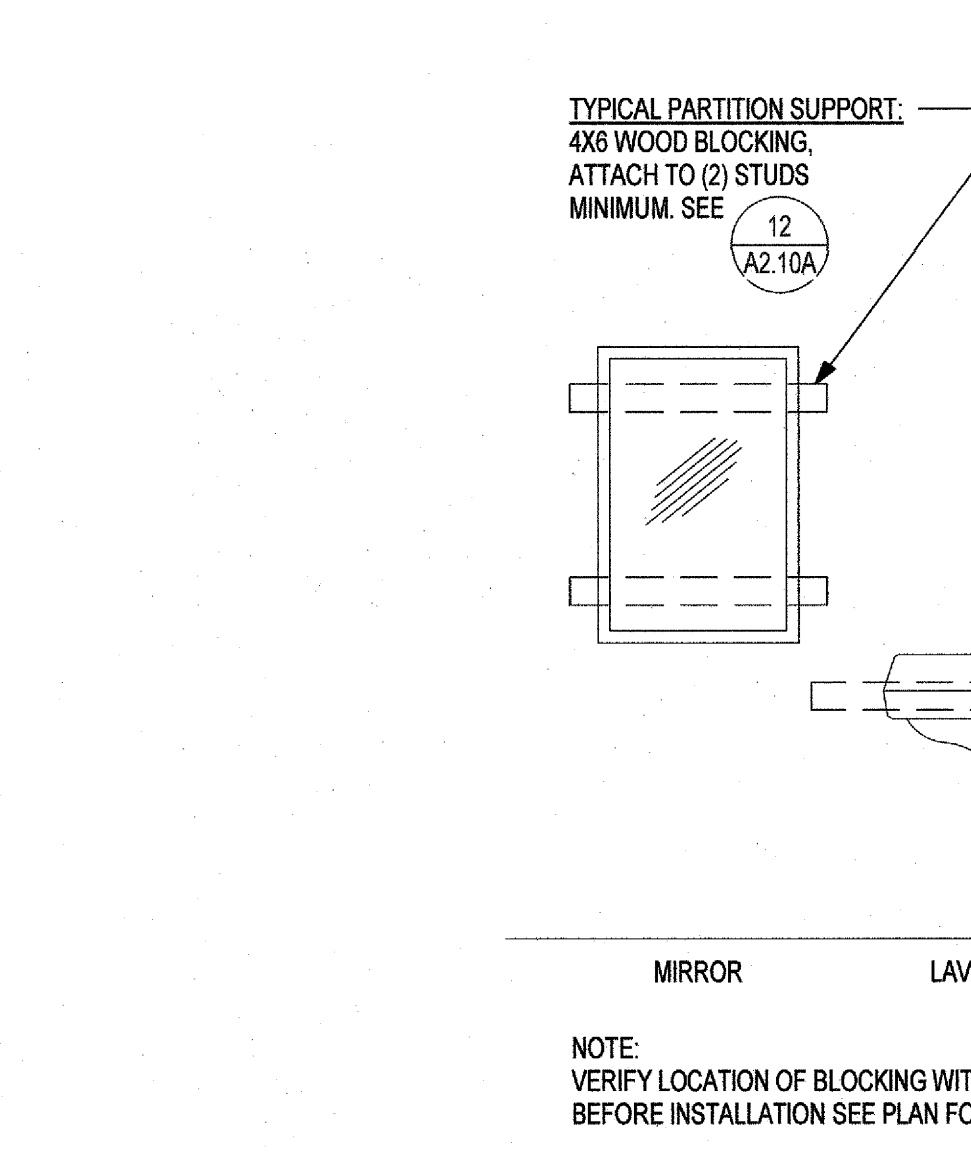


**10** WALL MOUNTED FIXTURE SUPPORT (WOOD BLOCK)  
 1 1/4" = 1'-0"




**9** NORTH ELEVATION - TOILET A1C  
 1/4" = 1'-0"

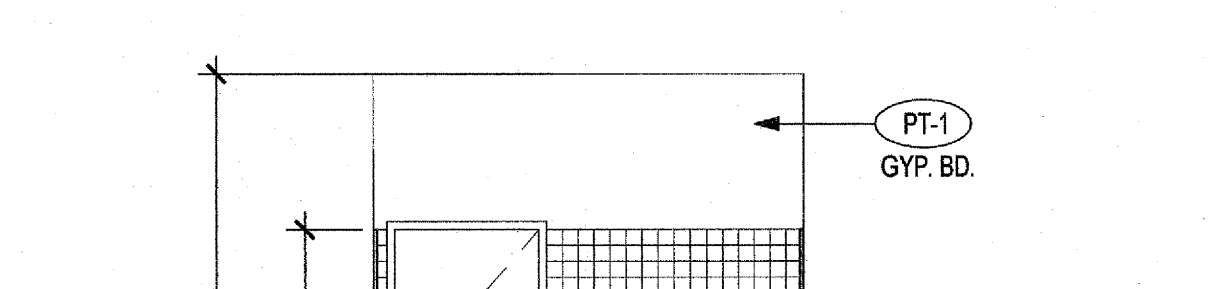


**8** EAST ELEVATION - TOILET A1C  
 1/4" = 1'-0"

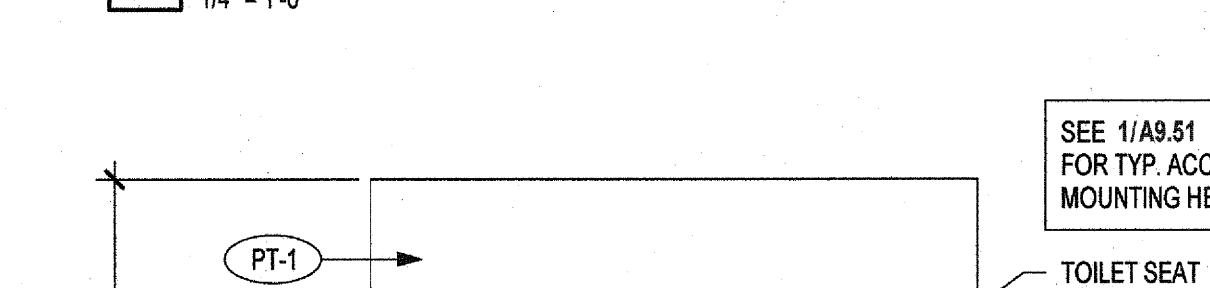

**7** SOUTH ELEVATION - TOILET A1C  
 1/4" = 1'-0"

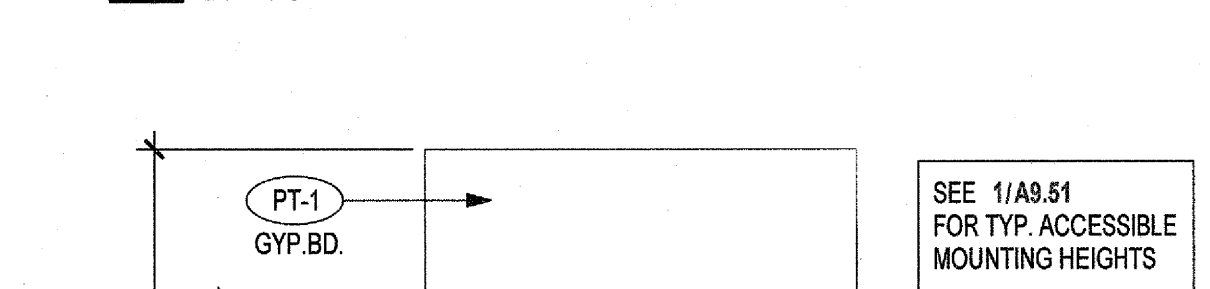

**6** WEST ELEVATION - TOILET A1C  
 1/4" = 1'-0"

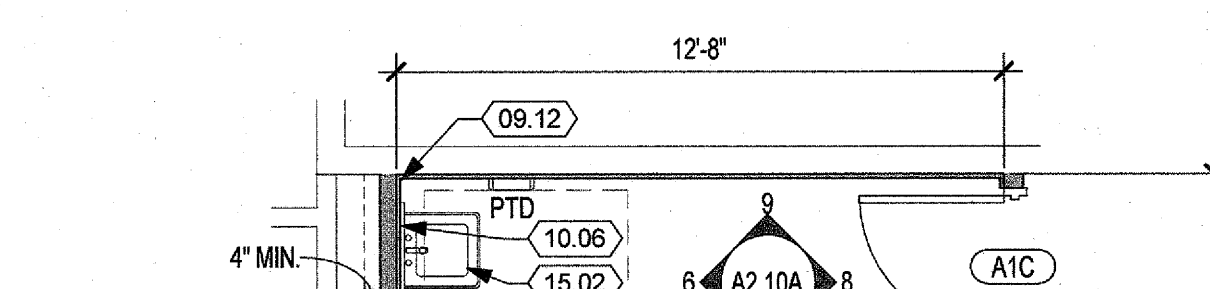


**5** ENLARGED PLAN - TOILET A1C  
 1/4" = 1'-0"



**4** REFLECTED CEILING PLAN - BLDG A PARTIAL  
 1/8" = 1'-0"




**2** FLOOR PLAN - BLDG A  
 1/8" = 1'-0"

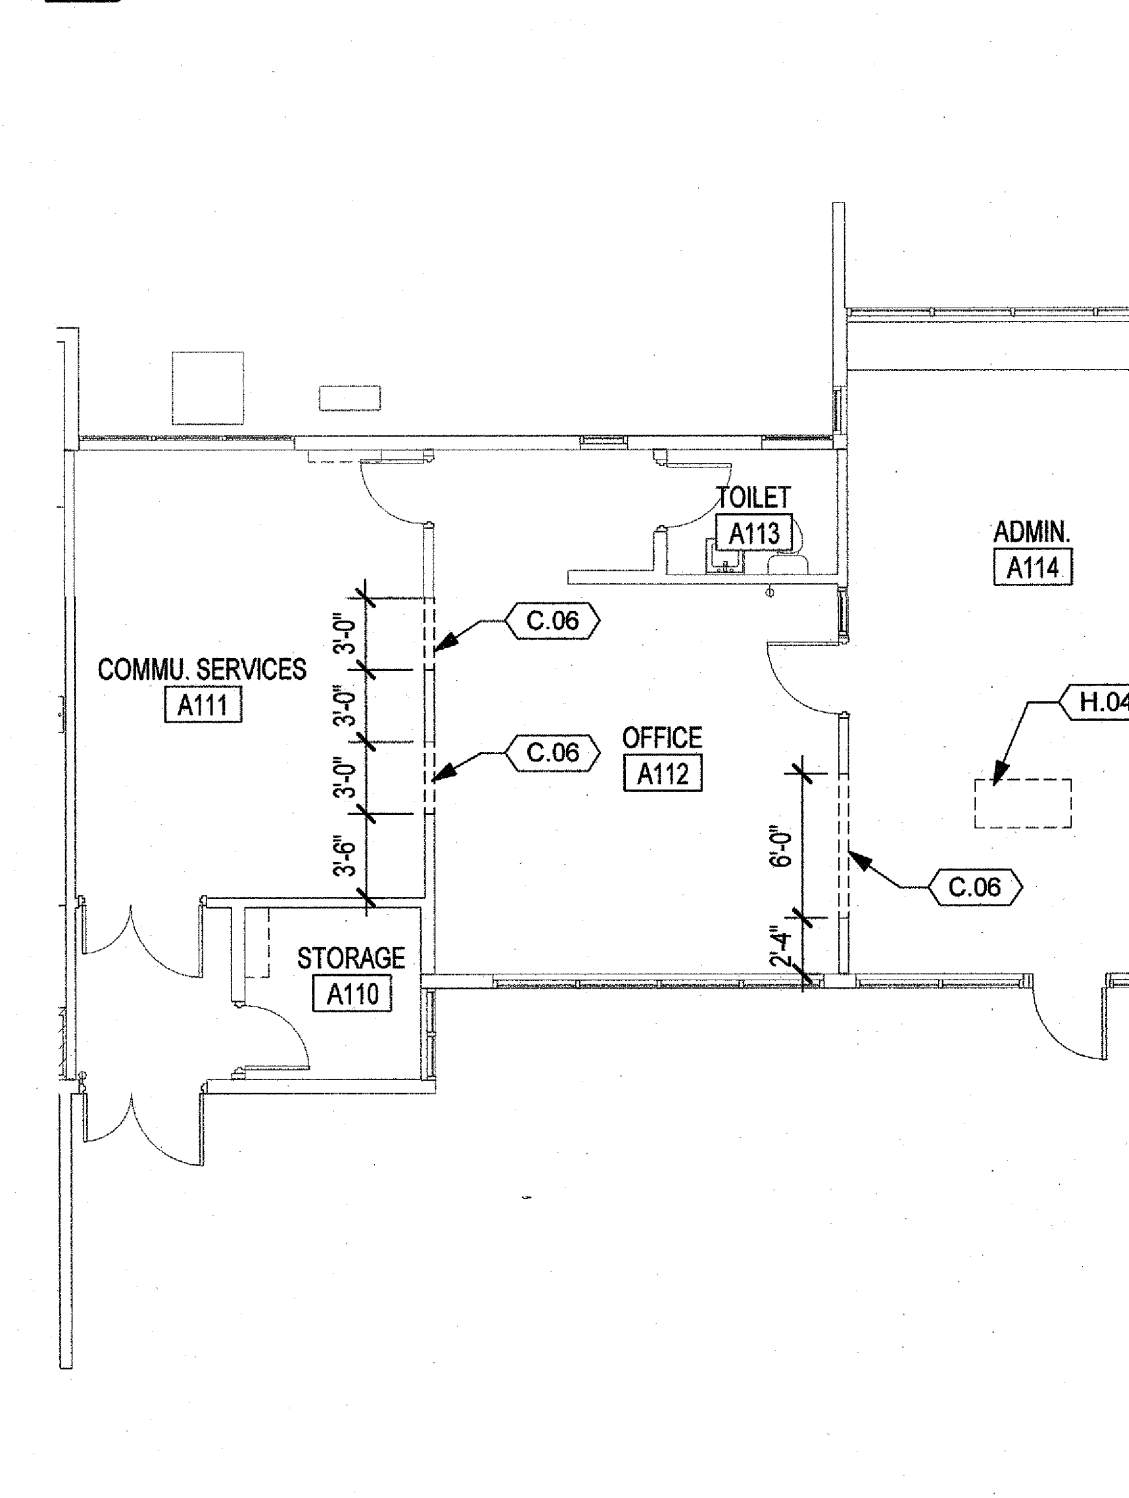


**1** DEMO PLAN - BLDG A  
 1/8" = 1'-0"



**3** DEMO REFLECTED CEILING PLAN - BLDG A PARTIAL  
 1/8" = 1'-0"

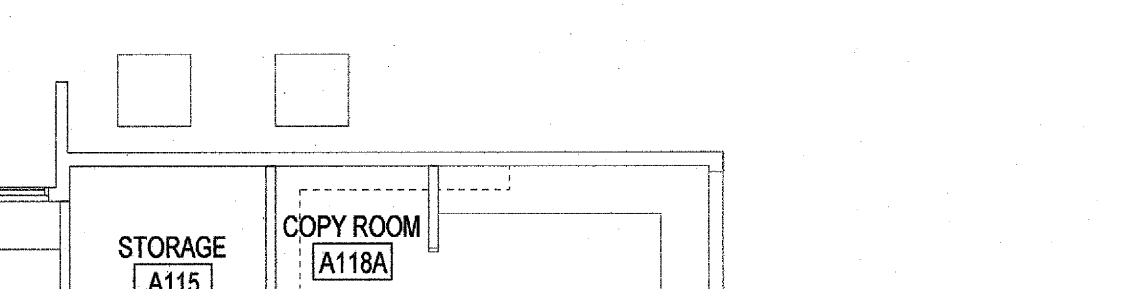

**2** FLOOR PLAN - BLDG A  
 1/8" = 1'-0"

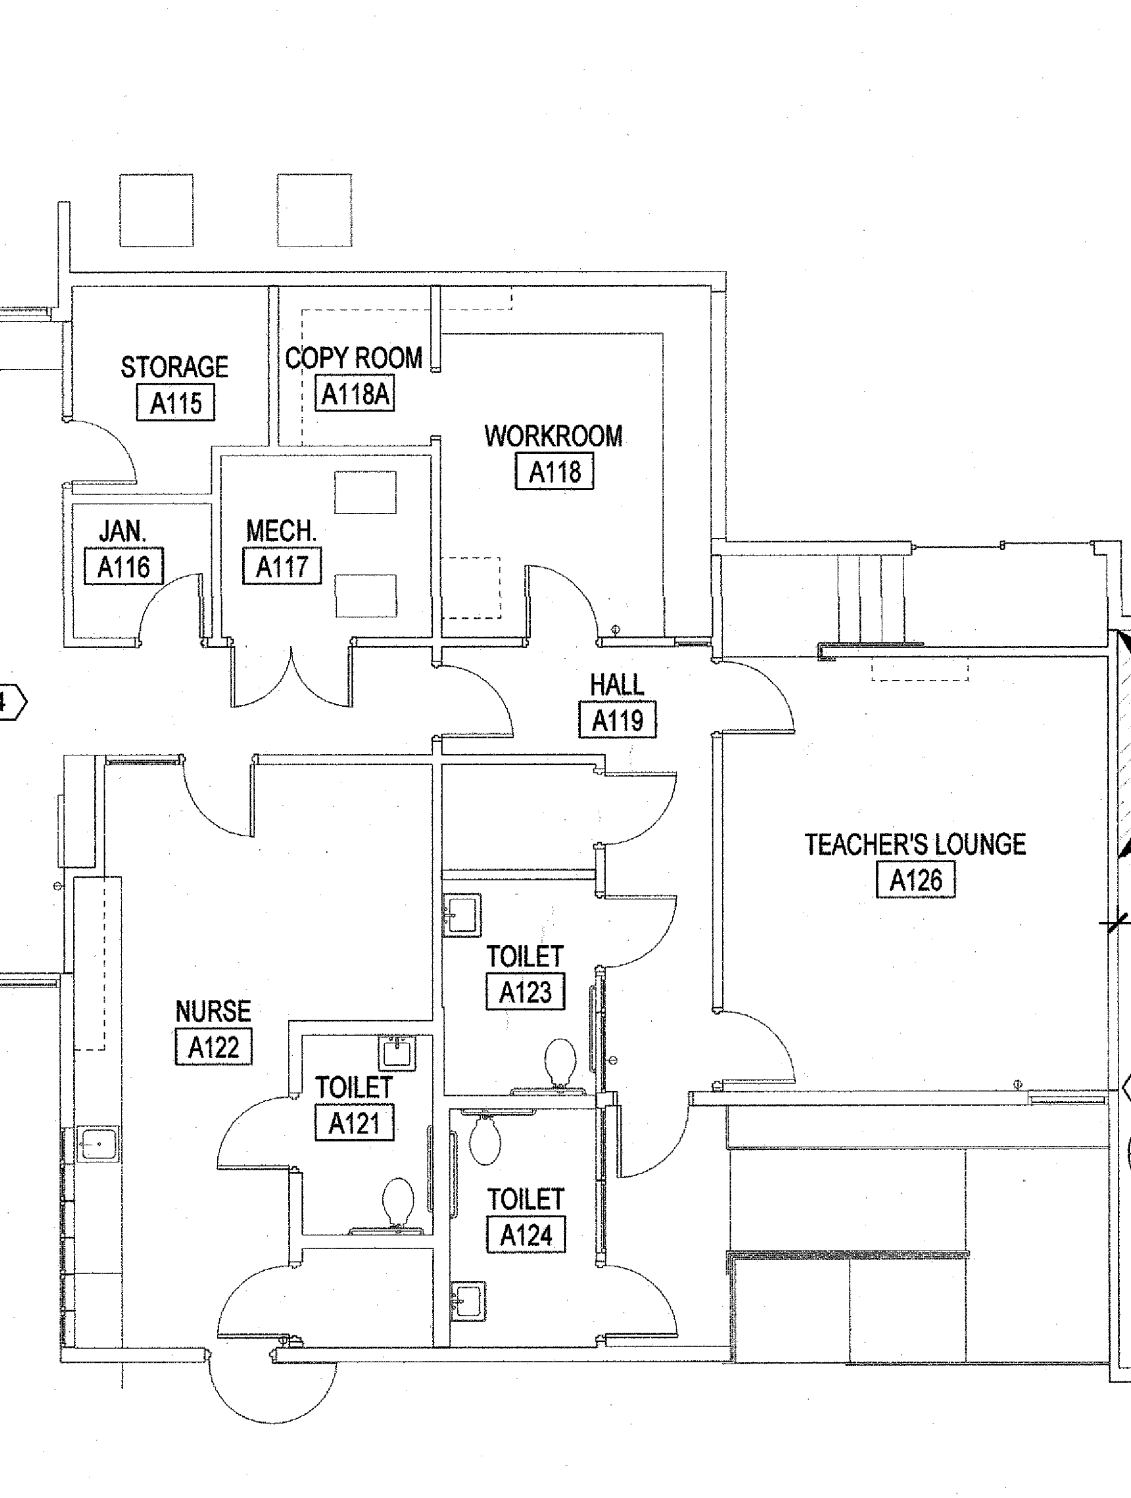


**1** DEMO PLAN - BLDG A  
 1/8" = 1'-0"



**3** DEMO REFLECTED CEILING PLAN - BLDG A PARTIAL  
 1/8" = 1'-0"




**2** FLOOR PLAN - BLDG A  
 1/8" = 1'-0"

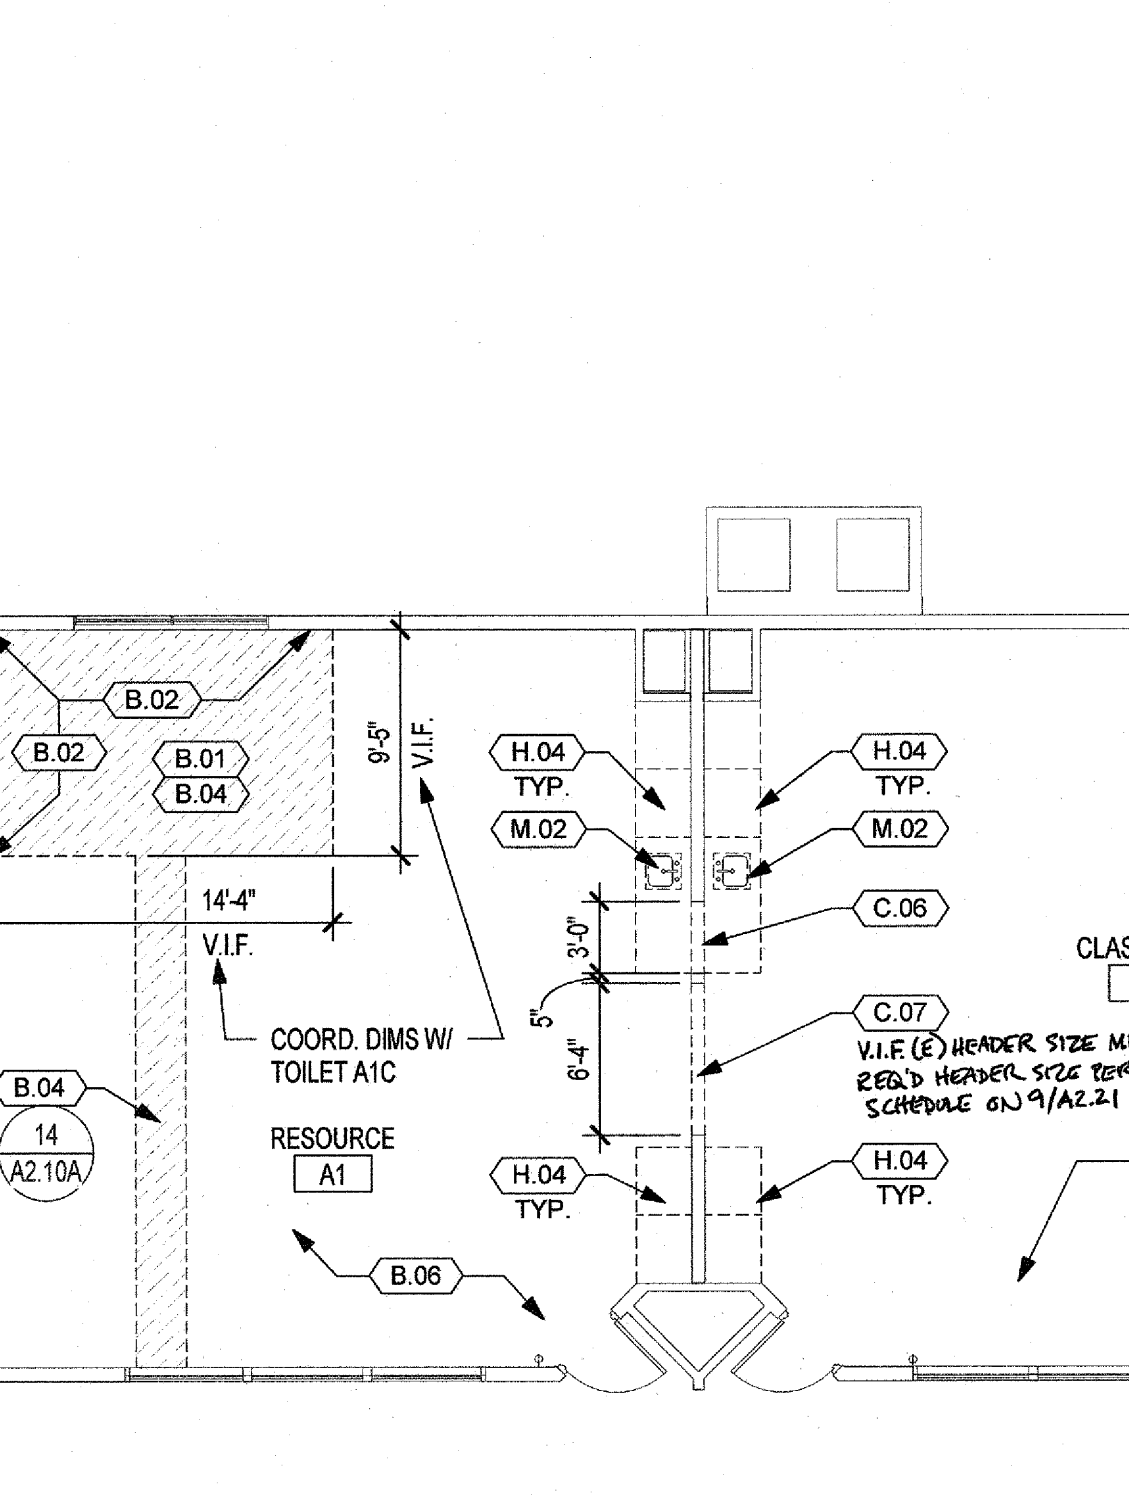

**1** DEMO PLAN - BLDG A  
 1/8" = 1'-0"





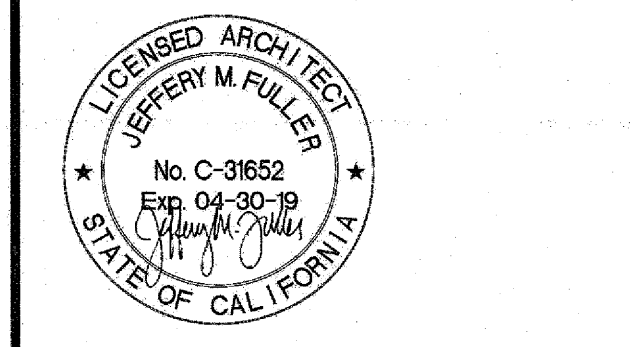


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**POINT DUME E.S.  
TEMPORARY HOUSING  
PROJECT**


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POINT DUME ELEMENTARY SCHOOL  
6965 Fernhill Dr., Malibu, CA 90265

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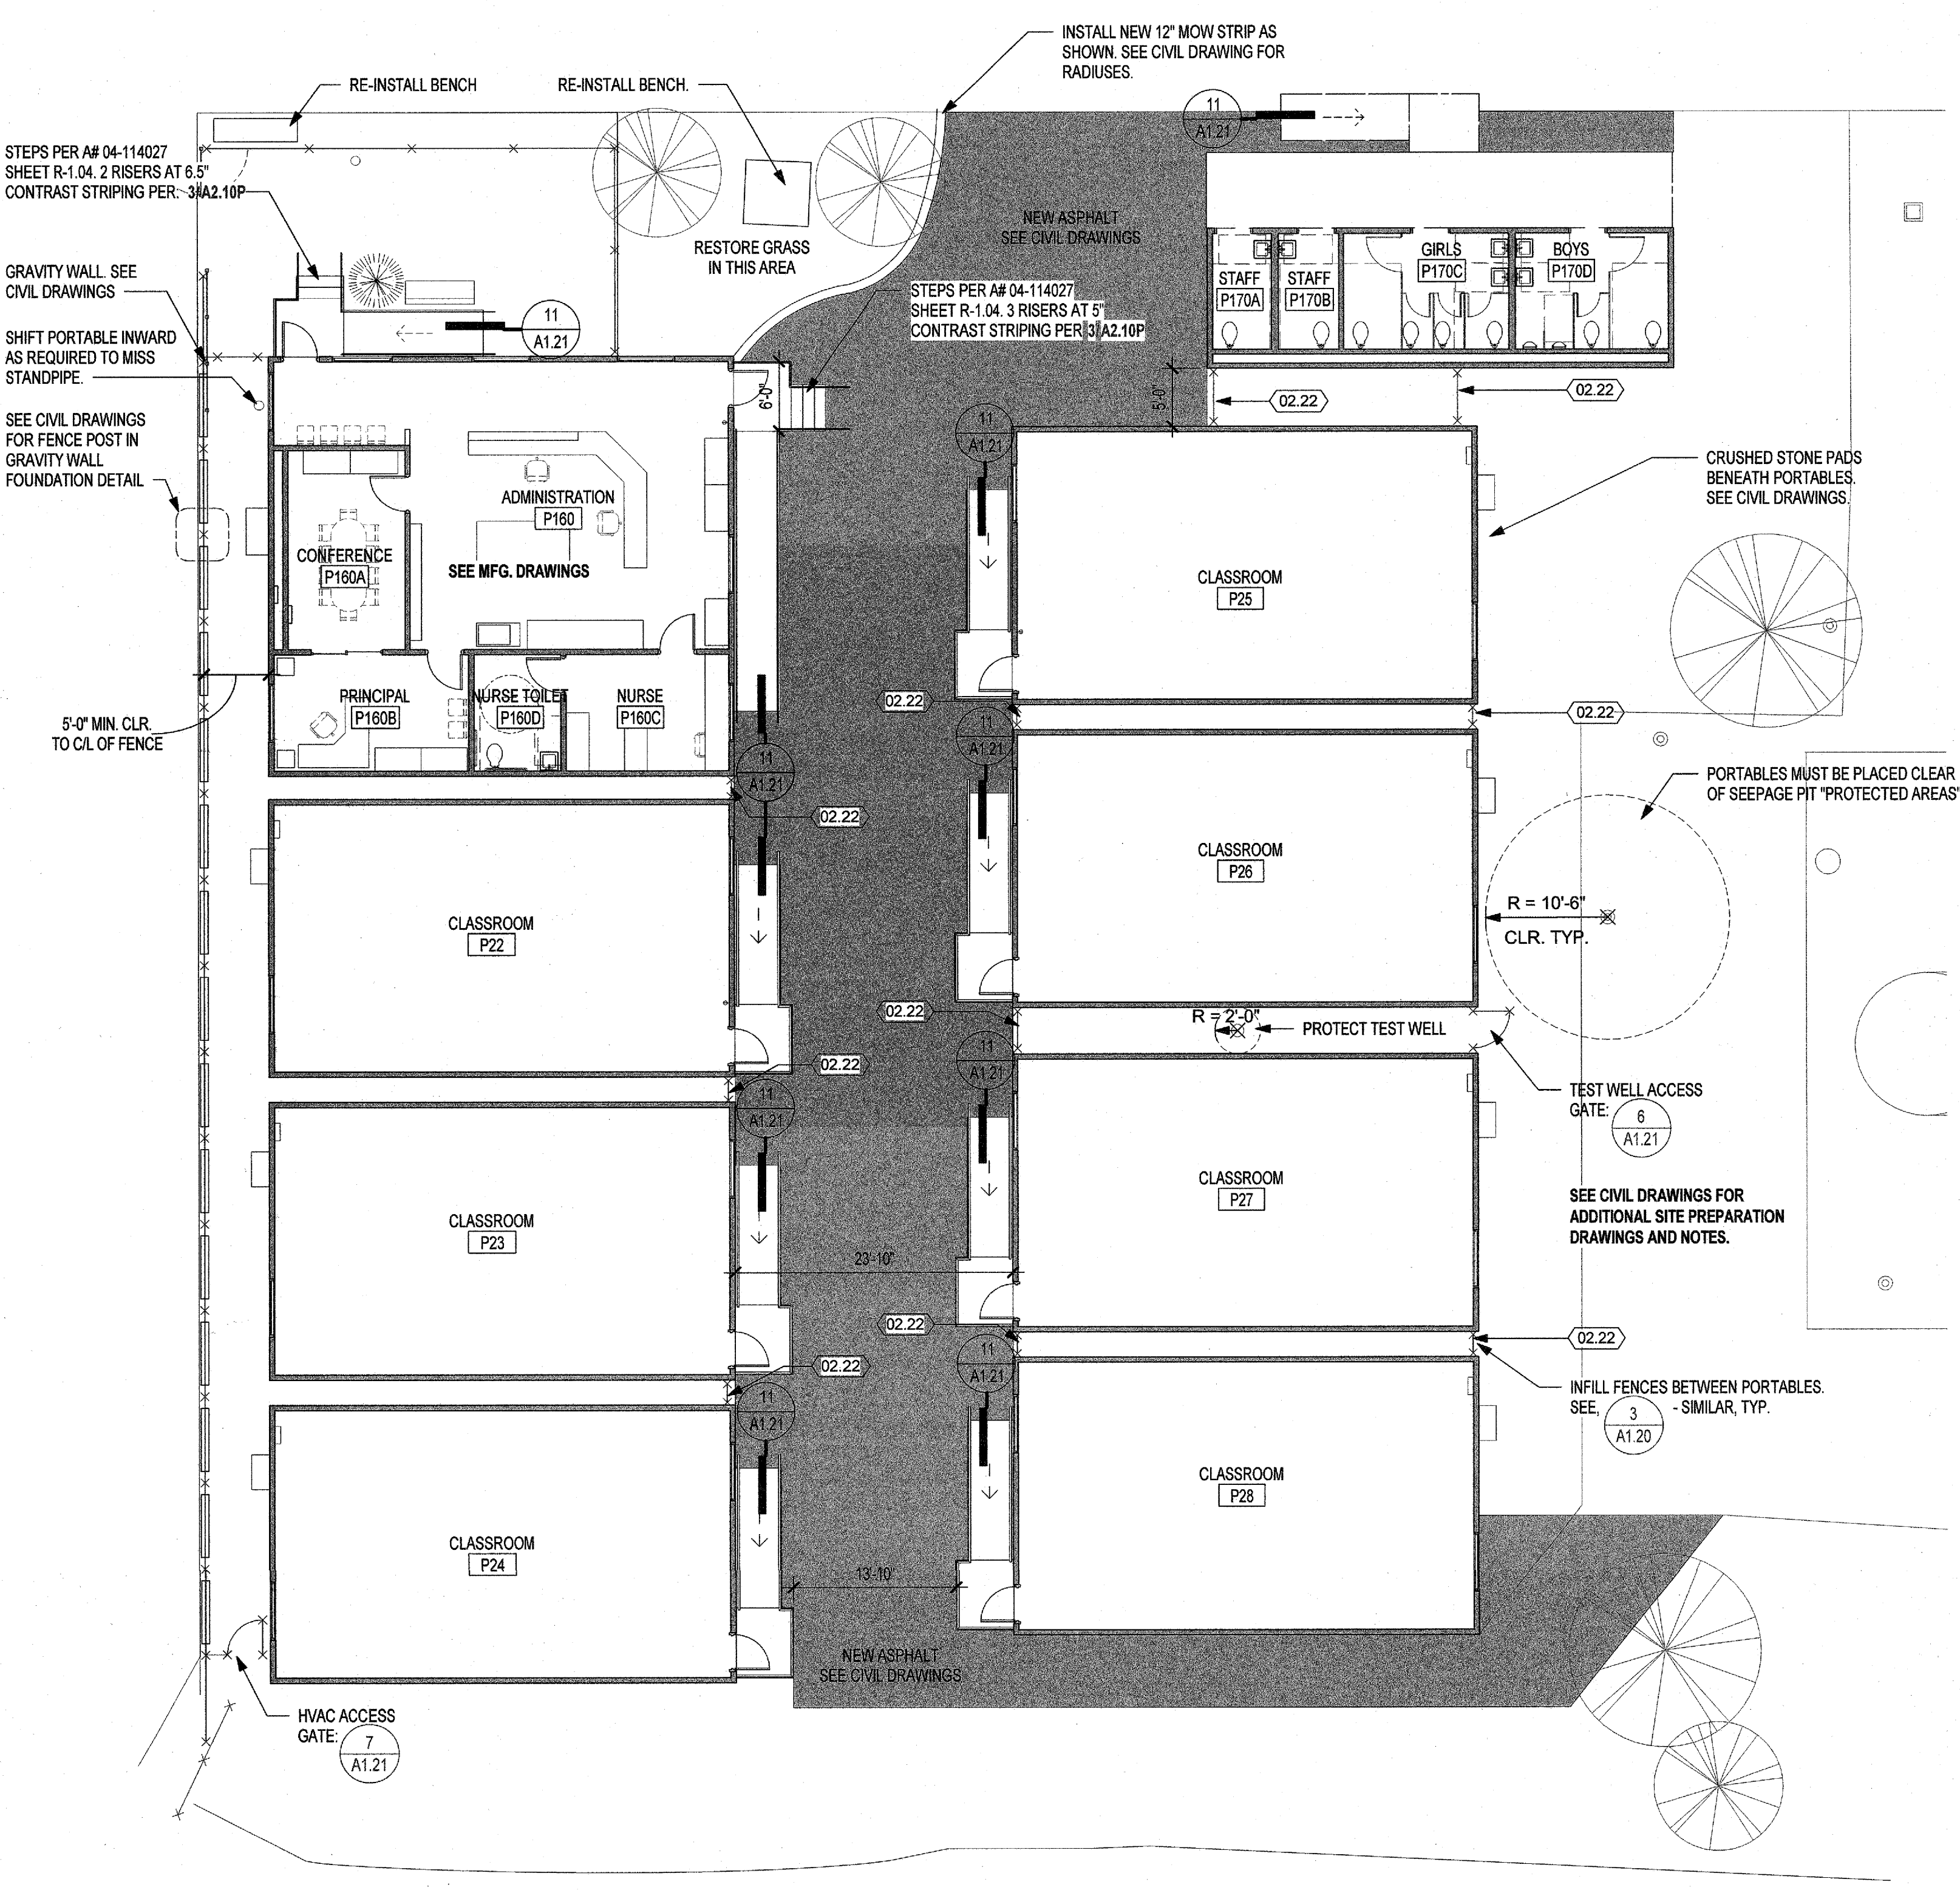


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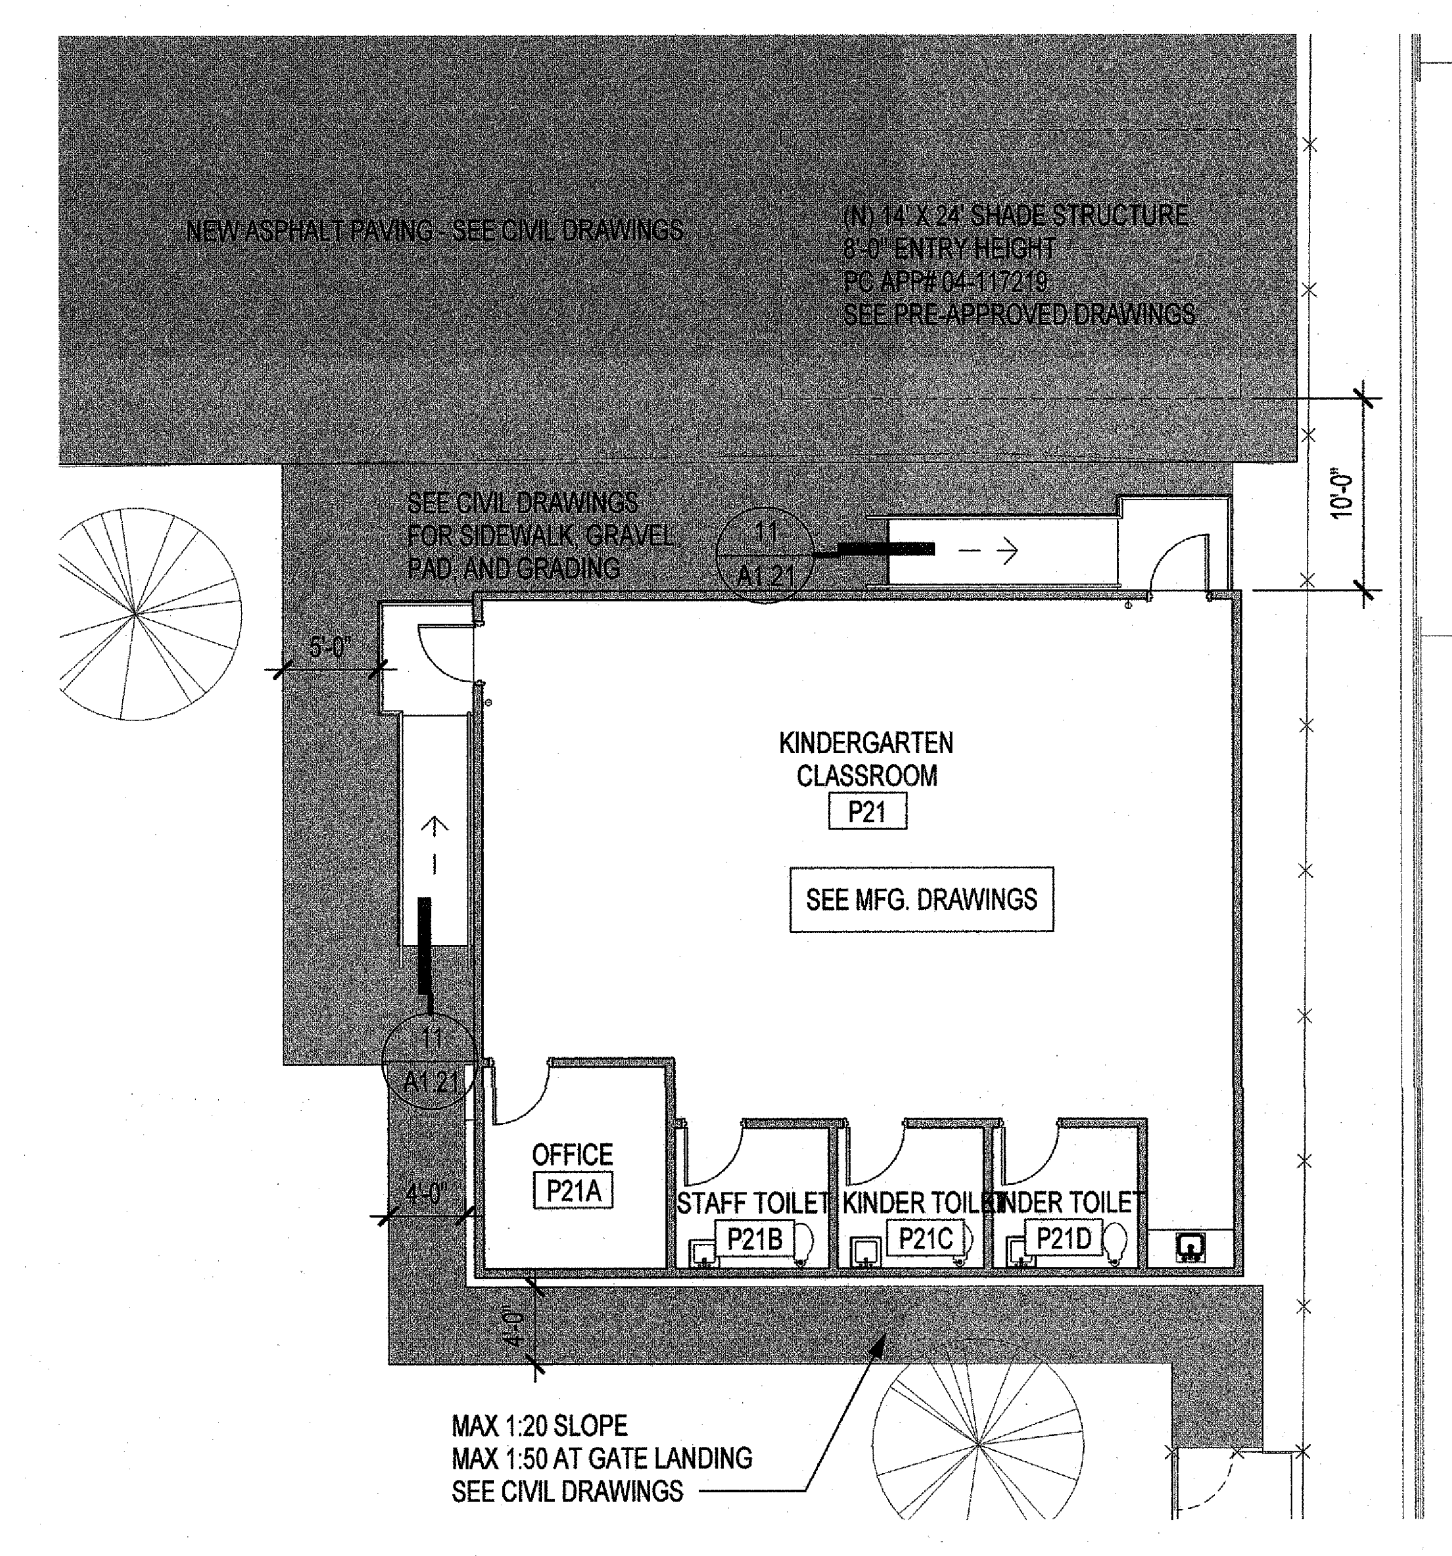
DATE	NO.	REVISIONS
2018/12/20	1	DSA BACKCHECK

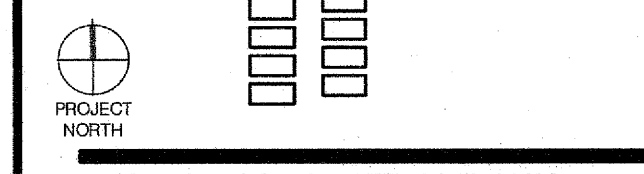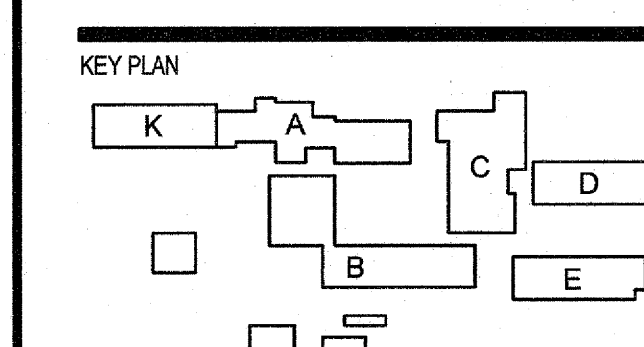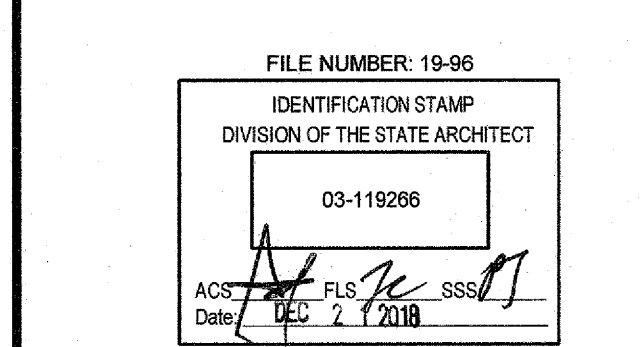

**3** TYPICAL STAIR CONTRAST STRIPING  
1" = 1'-0"

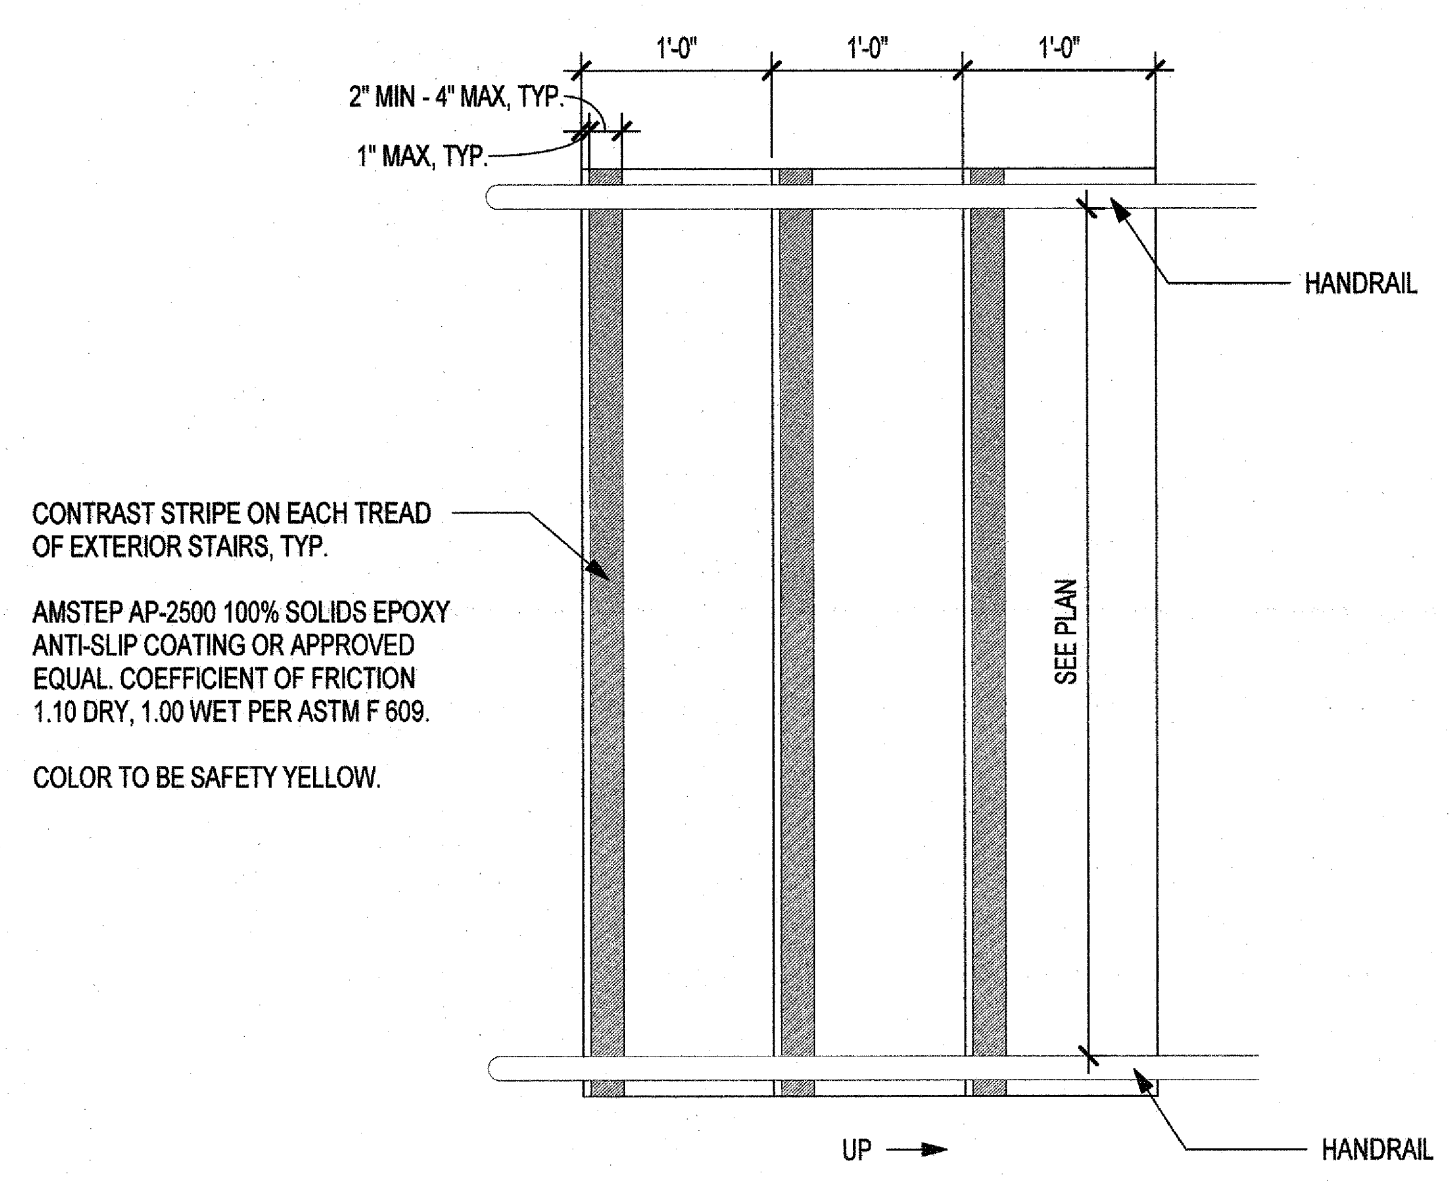

**2** LOWER CAMPUS PORTABLES  
1" = 1'-0"



**1** KINDERGARTEN PORTABLE  
1" = 1'-0"

- SITE SPECIFIC APPLICATION PLAN FOR SHADE STRUCTURE**
- SHADE STRUCTURE TO BE 14' X 24'
  - FOR DIMENSIONS FROM ADJACENT BUILDINGS AND PROPERTY LINES, SEE 1/A0.02
  - FOR CODE ANALYSIS WITH REGARD TO SHADE STRUCTURE, SEE A0.01
  - FOR NEAREST FIRE EXTINGUISHER, SEE 2/A0.04
  - NEAREST FIRE ALARMS ARE LOCATED IN KINDERGARTEN PORTABLE. SEE ELECTRICAL DRAWINGS OF KINDERGARTEN PORTABLE.
  - SHADE STRUCTURE IS IN MALIBU. SNOW LOAD AND SNOW CLEARANCE ARE NOT A DESIGN FACTOR.
  - SHADE STRUCTURE INSTALLED AT 136.5 FT ABOVE SEA LEVEL. SEE CIVIL DRAWINGS. SNOW LOAD AND SNOW CLEARANCE ARE NOT A DESIGN FACTOR AT THIS SITE.
  - N/A
  - STRUCTURE TO BE MODEL DSA0120312-16, PCA 04-117219. ACTUAL SIZE 14' X 24'
  - ALL SADDLES, CLAMPS, AND FITTINGS SHALL CONFORM TO THE GUIDELINES AS SPECIFIED IN APPENDICES 'A', 'B' & 'C' RESPECTIVELY IN ASCE 19-10, "STRUCTURAL APPLICATIONS OF STEEL CABLES FOR BUILDINGS."
  - GEO-HAZARD REPORT NOT REQUIRED PER DSA IR-A-13, SECTION 3.1.1. (REGULAR HIPPED SHADE STRUCTURE < 1600 SF SUPPORTED AT ALL 4 CORNERS W/ COLUMN SPACING < 40 FT)

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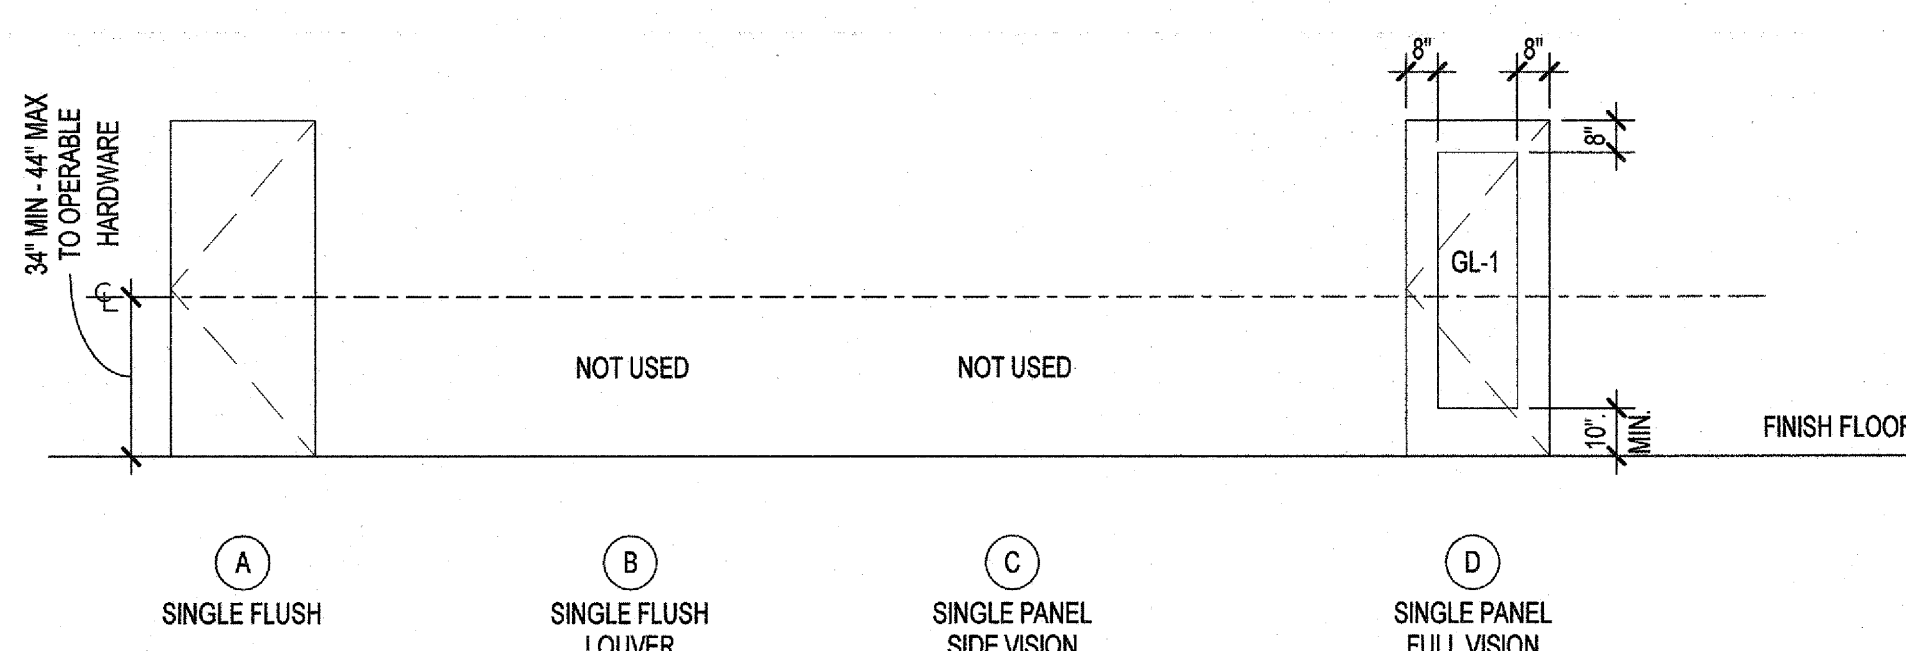
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SHEET NUMBER  
**A2.10P**  
DRAFTER: Author    P.M.J.    REVIEWER: JP


DOOR SCHEDULE																										
ROOM		DOOR										FRAME				DETAILS				HARDWARE				PLACE IN (E) OPENING*	GENERAL REMARKS	
NO.	NAME	HDW SET	NO.	NEW	RIOR	WIDTH	HGT.	TYPE	MAT.	FINISH	GLASS	NEW	MAT.	TYPE	FINISH	FIRE RATING	STC	HEAD	JAMB	THRESH	NEW	THRESH	PANIC	CLOSER	OPENING*	
A1	RESOURCE	1	A1	Yes	No	6'-0"	7'-0"	D	WD	CV	GL-1	Yes	HM	B	PT-1	-	-	2/A2.21	1/A2.21	-	Yes	No	No	No	No	
A1A	OFFICE	2	A1A	Yes	No	3'-0"	7'-0"	A	WD	CV	-	Yes	HM	A	PT-1	-	-	5/A2.21	5/A2.21	-	Yes	No	No	No	No	
A1B	STORAGE	3	A1B	Yes	No	3'-0"	7'-0"	A	WD	CV	-	Yes	HM	A	PT-1	-	-	5/A2.21	5/A2.21	-	Yes	No	No	No	No	
A1C	TOILET	4	A1C	Yes	No	3'-0"	7'-0"	A	WD	CV	-	Yes	HM	A	PT-1	-	-	5/A2.21	5/A2.21	8/A2.21	Yes	Yes	No	Yes	No	
Grand total: 4																										

**DOOR TYPES**

COMPLIANT WITH 2016 CBC



**FRAME TYPES**

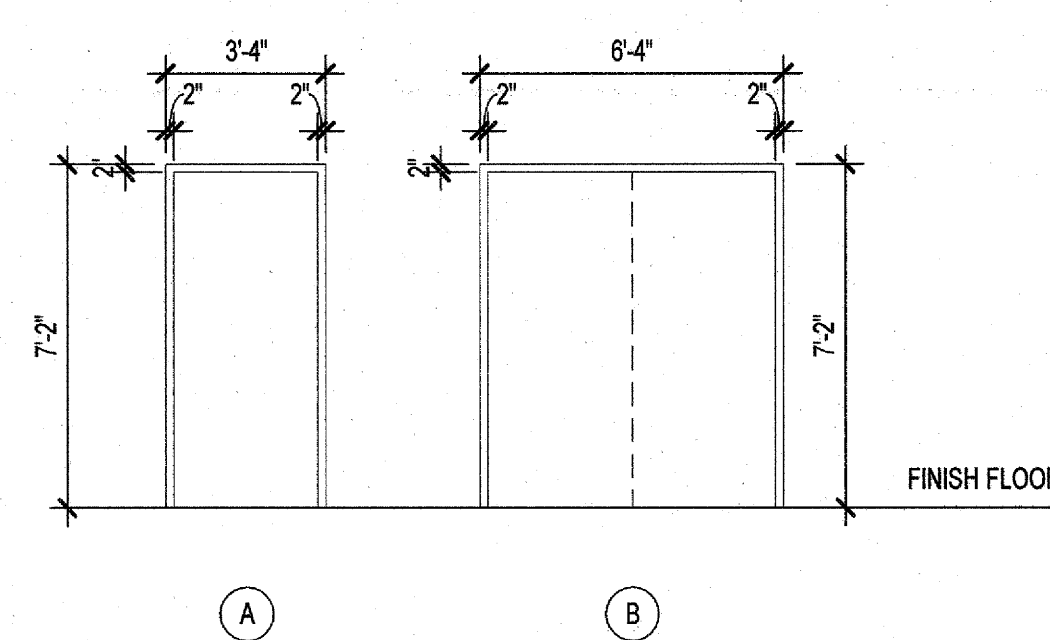

**DOOR SCHEDULE LEGEND**

**MATERIALS**


- AL ALUMINUM
- HM HOLLOW METAL
- MTL METAL
- SS STAINLESS STEEL
- STL STEEL
- WD WOOD
- FF FACTORY FINISH
- CV CLEAR VARNISH - FACTORY FINISH FOR WOOD
- PT PAINT
- EX EXISTING MATERIAL
- GL-1 ALL VISION PANELS TO BE SINGLE GLAZE, CLEAR GLASS, IMPACT RESISTANT. SEE GLAZING SPECIFICATIONS.

**ABBREVIATIONS**

- SF DOOR IS FRAMED BY A STOREFRONT WINDOW SYSTEM
- PRE-OPEN PAIR DOORS
- U UNEVEN PAIR DOORS WITH ONE LEAF AT 3'-0" WIDTH
- \* BLANK OR 'NO' IN COLUMN IS EQUIVALENT TO PLACE IN NEW FRAMED OPENING

**DOOR NOTES**

- A. ALL FIRE RATED DOORS SHALL BE POSITIVE LATCHING AND SELF-CLOSING OR ACTIVATED BY SMOKE DETECTOR PER C.B.C. SECTION 716
- B. DOOR HARDWARE GROUPS LOCATED IN PROJECT MANUAL SECTION 08 70 00
- C. ALL EXT DOORS SHALL BE OPENABLE FROM THE INSIDE WITHOUT THE USE OF A KEY OR ANY SPECIAL KNOWLEDGE OR EFFORT.
- D. ALL NEW FRAMES ARE 2" NOMINAL U.O.N.
- E. FOR FINISHES SEE SPECIFICATIONS.
- F. EXISTING HARDWARE TO REMAIN FOR DOORS NOT GETTING NEW HARDWARE
- G. THE CONTRACTOR IS TO PROVIDE A WORKING SYSTEM AND ENSURE COMPATIBILITY OF DOOR ASSEMBLY AND NEW HARDWARE.
- H. FURNISH A WOODWORK INSTITUTE W1 CERTIFIED COMPLIANCE LABEL ON EACH WD DOOR.
- J. THE FORCE FOR PUSHING OR PULLING OPEN INTERIOR SWINGING EGRESS DOORS, OTHER THAN FIRE DOORS SHALL NOT EXCEED 5 LBS. FOR EXTERIOR DOORS THE DOOR LATCH SHALL RELEASE WHEN SUBJECTED TO A 5 LBS. FORCE
- K. DIMENSIONS FOR EXISTING DOORS ARE APPROXIMATE, V.I.F.
- L. DIMENSIONS FOR NEW DOORS IN EXISTING OPENINGS APPROXIMATE, V.I.F.
- M. FIRE RATED GLAZING TO MATCH FIRE RATING OF DOOR ASSEMBLY. GLAZING SHALL ALSO BE IMPACT RATED.
- N. NEW DOOR THICKNESS 1 3/4"
- O. NOT USED
- P. VERIFY 'N' FIELD (E) OPENING DIMENSIONS FOR (N) DOORS AND FRAMES
- Q. NEW 10" DOOR WIDTH STAINLESS STEEL KICKPLATE AT ALL (N) DOORS
- R. EXISTING DOOR LEAF DESIGN MAY NOT MATCH SITE CONDITIONS. THEY ARE SHOWN FOR GRAPHICS ONLY TO SHOW HEIGHT & WIDTH
- S. SALVAGE ALL HARDWARE THAT ARE BEING REMOVED. INVENTORY ALL EXISTING HARDWARE FOR EACH DOOR THAT IS BEING UPGRADED. AS PART OF INVENTORY PROCESS, EACH DOOR BE PHOTOGRAPHED FROM BOTH SIDES TO SHOW ALL HARDWARE, HARDWARE FUNCTIONS, AND LATCH SIDE CLEARANCES COORDINATE WITH SAN FRANCISCO UNIFIED DISTRICTS' BUILDINGS AND GROUNDS LOCK SHOP SUPERVISOR. THE SMMUSD LOCKSHOP RETAINS SALVAGE RIGHTS TO DOOR LOCKS & HARDWARE
- T. INFILL SHIM AND FRAMING ARE EXPECTED TO SECURE NEW DOOR FRAMES BEING PLACED IN (E) OPENINGS.


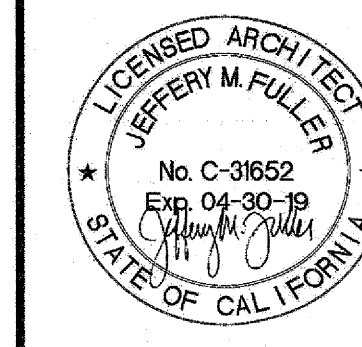


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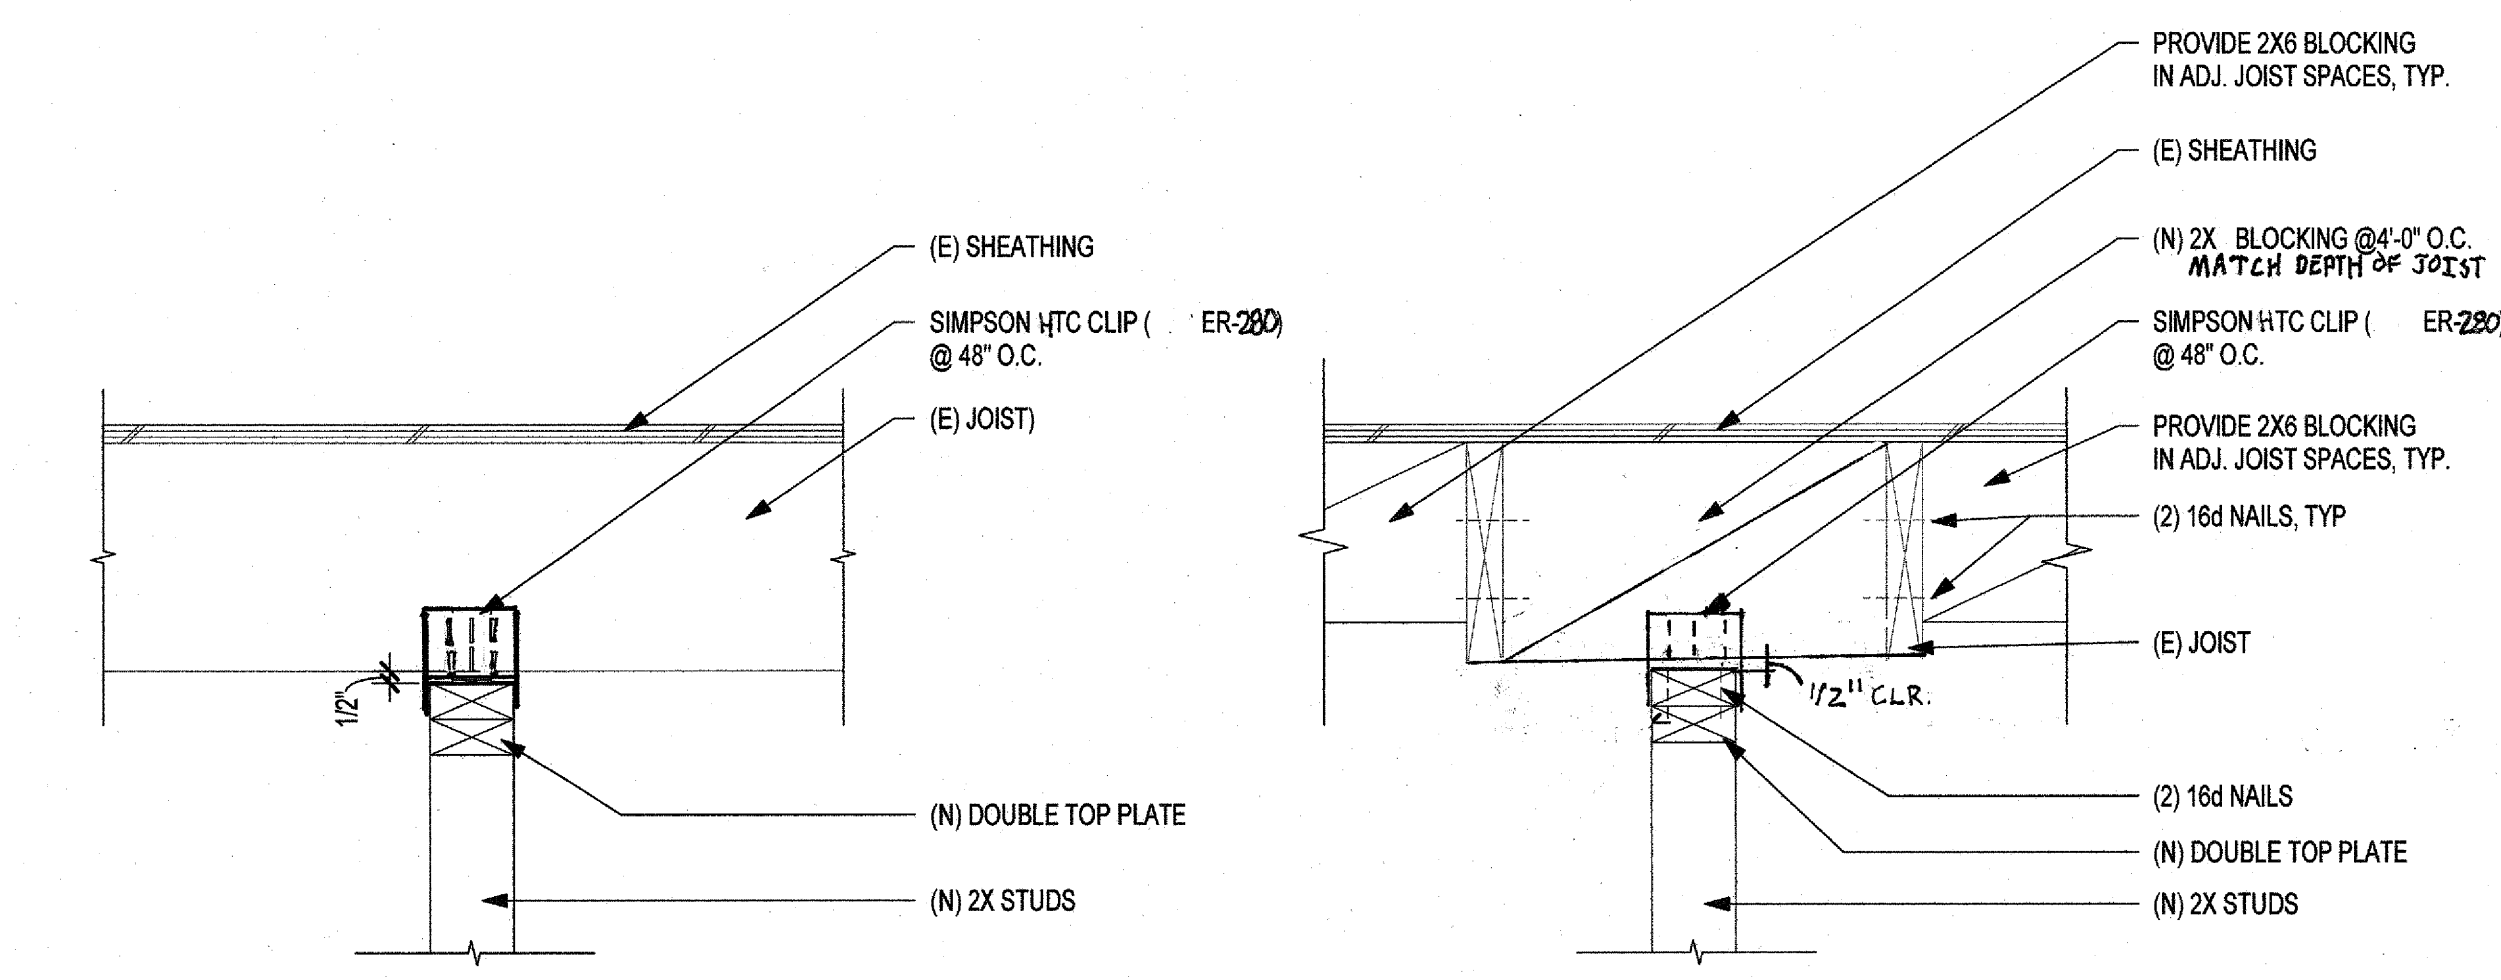
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6555 Fernhill Dr, Malibu, CA 90265

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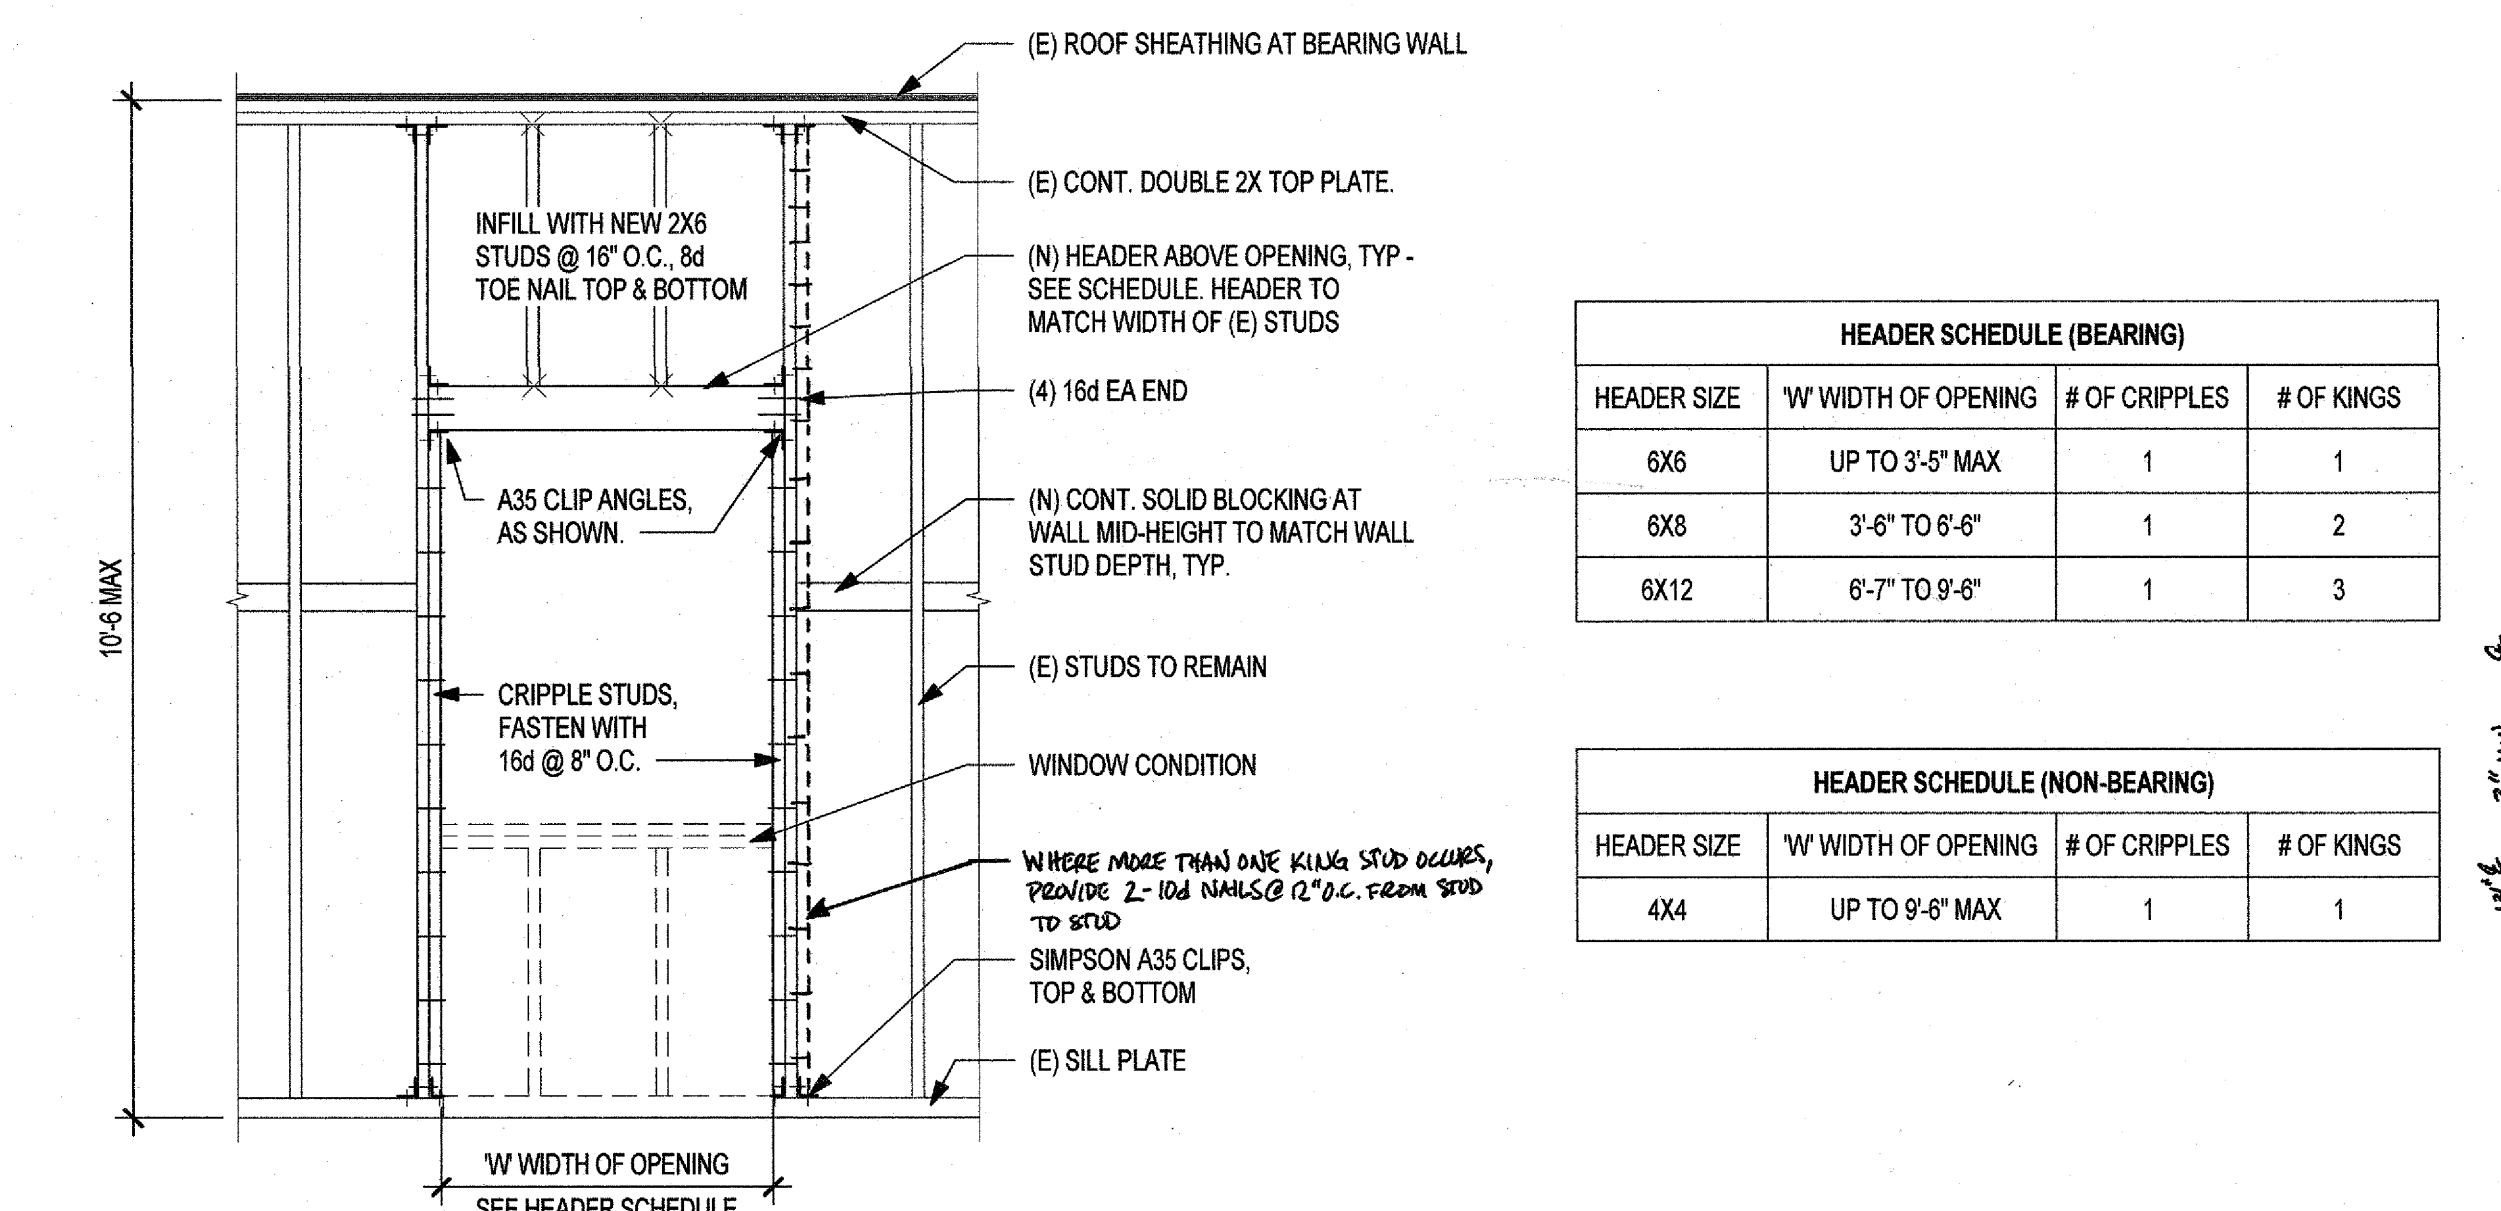
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DATE	NO.	REVISIONS




**PERPENDICULAR TO JOIST**      **PARALLEL TO JOIST**

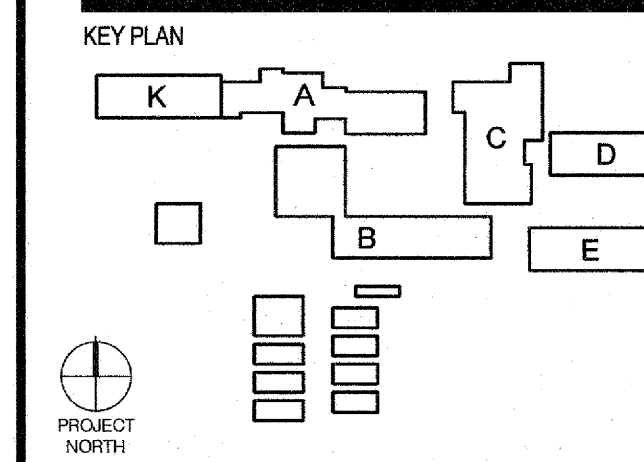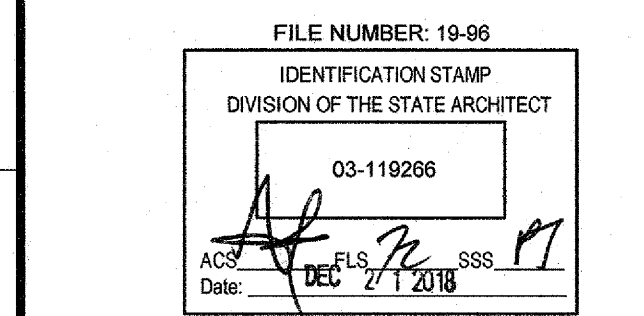
**10 TOP OF WALL DETAIL (NON-BEARING)**  
1 1/2" = 1'-0"




**9 TYP. HEADER FRAMING DETAIL & SCHEDULE**  
1/2" = 1'-0"

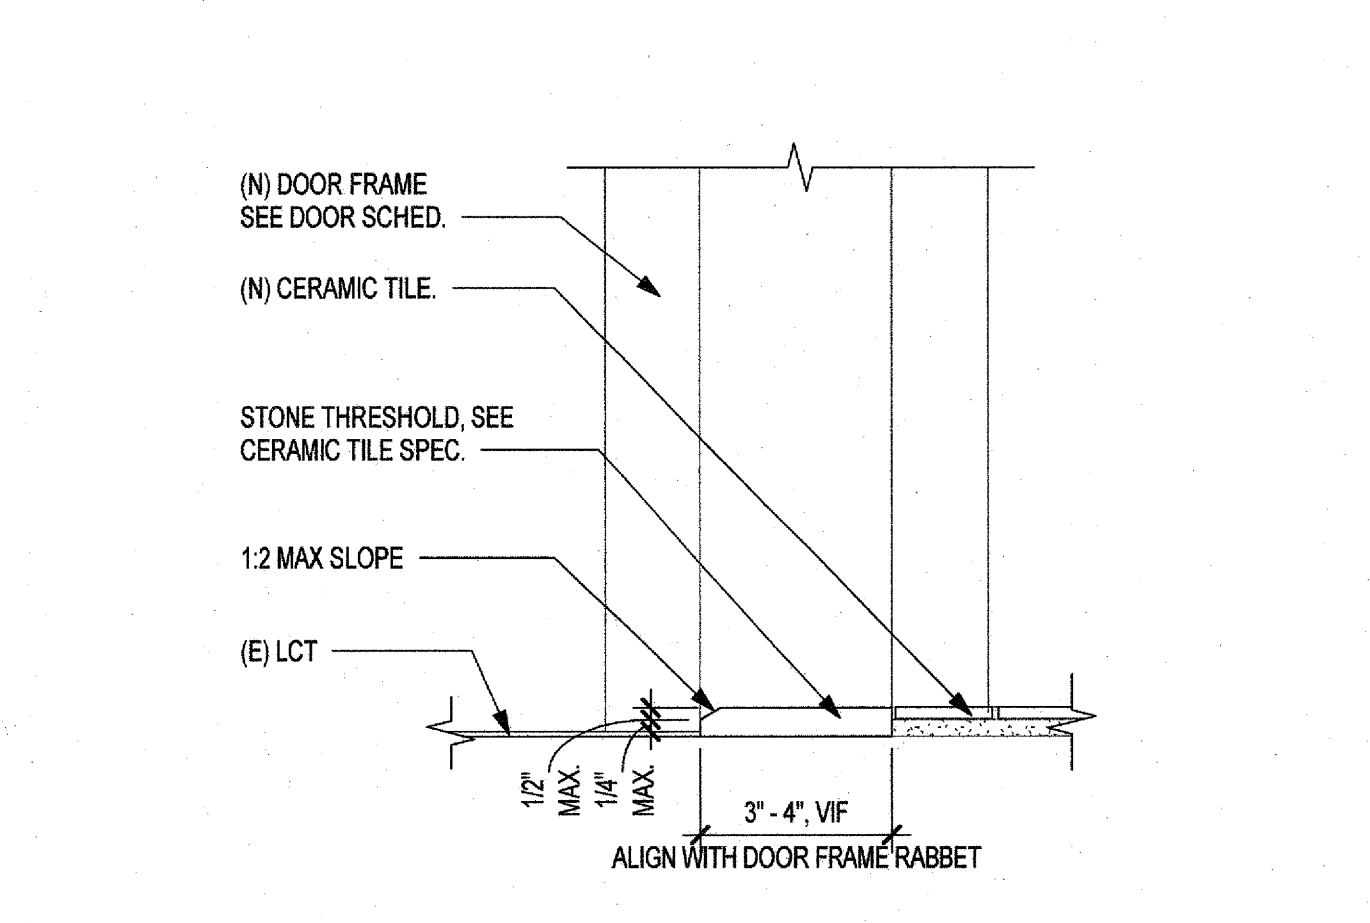


**8 MARBLE THRESHOLD DETAIL**  
3" = 1'-0"

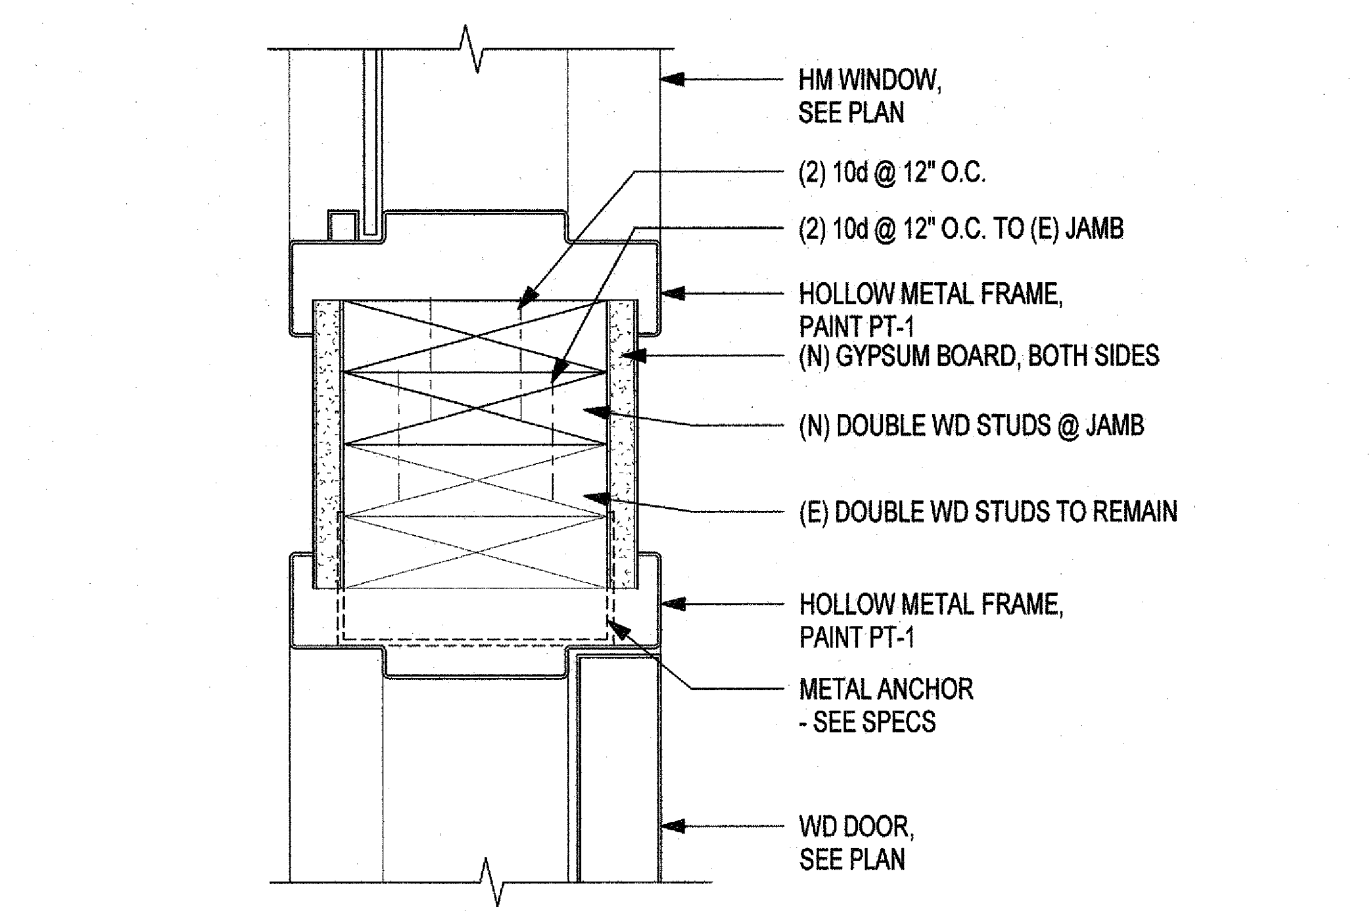


**7 JAMB DETAIL AT DOOR A1 & WINDOW W1**  
3" = 1'-0"

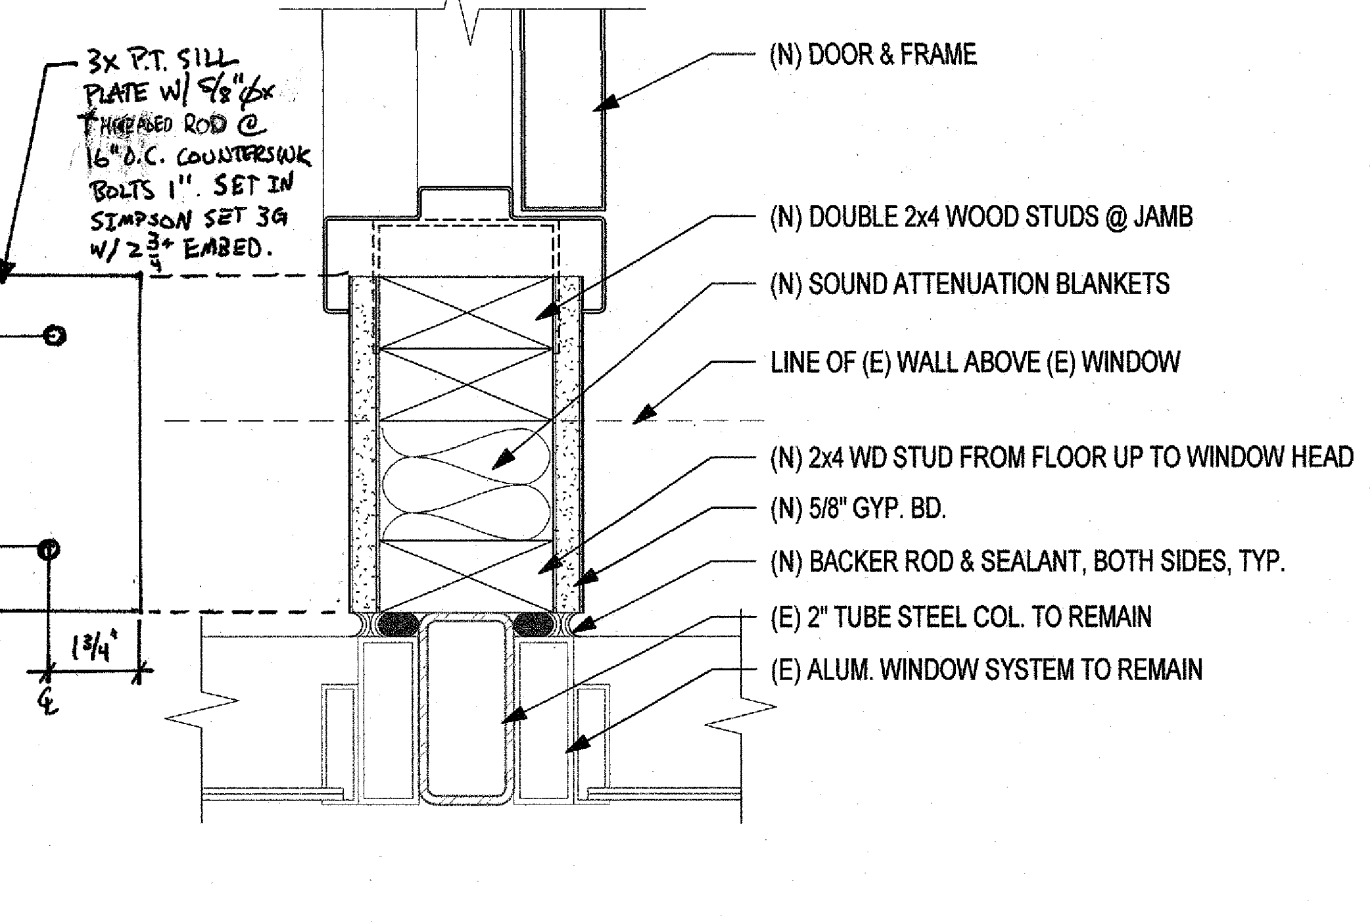


**6 WALL INTERSECTION PLAN DETAIL @ ALUM. WINDOW**  
3" = 1'-0"

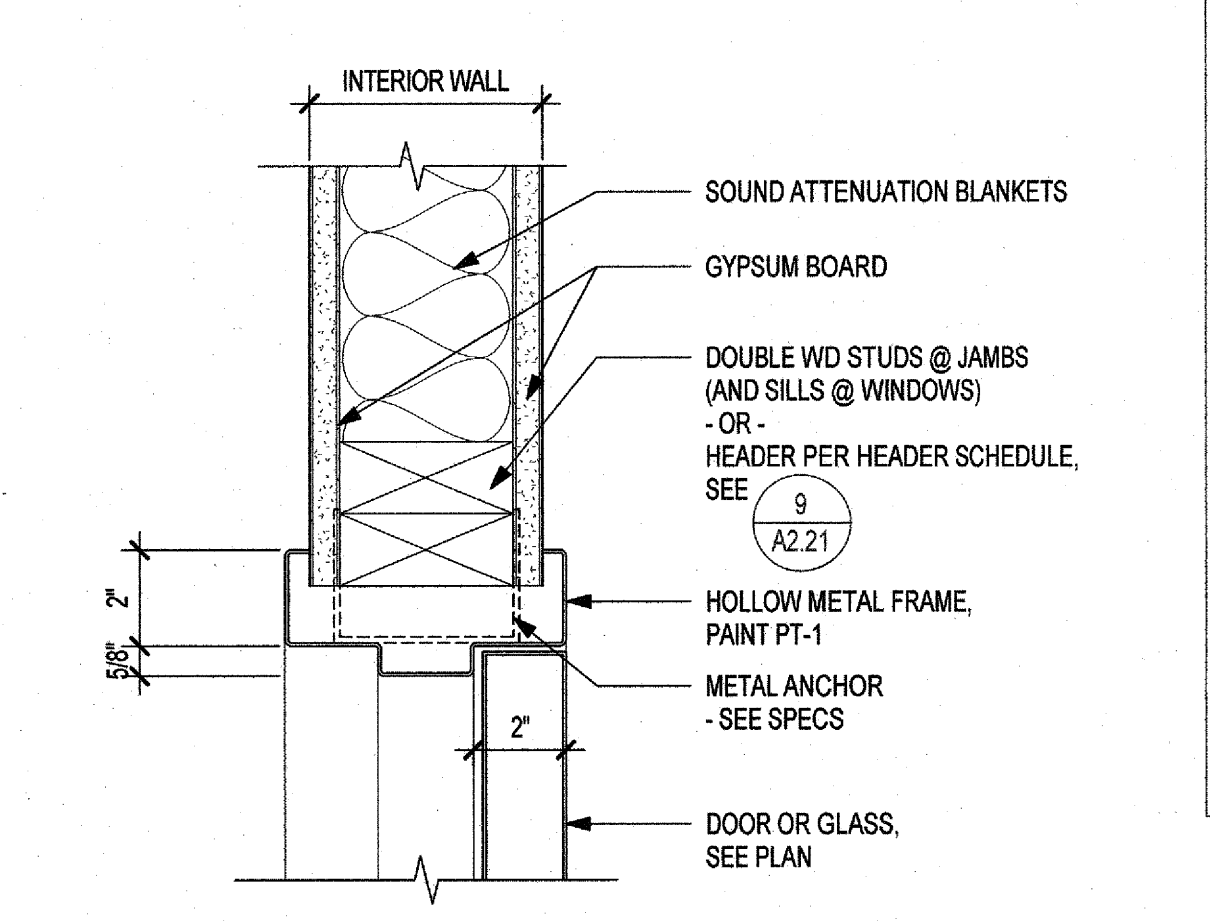


**5 NEW INTERIOR HM FRAME HEAD/JAMB DETAIL (NEW WALL CONSTRUCTION)**  
3" = 1'-0"

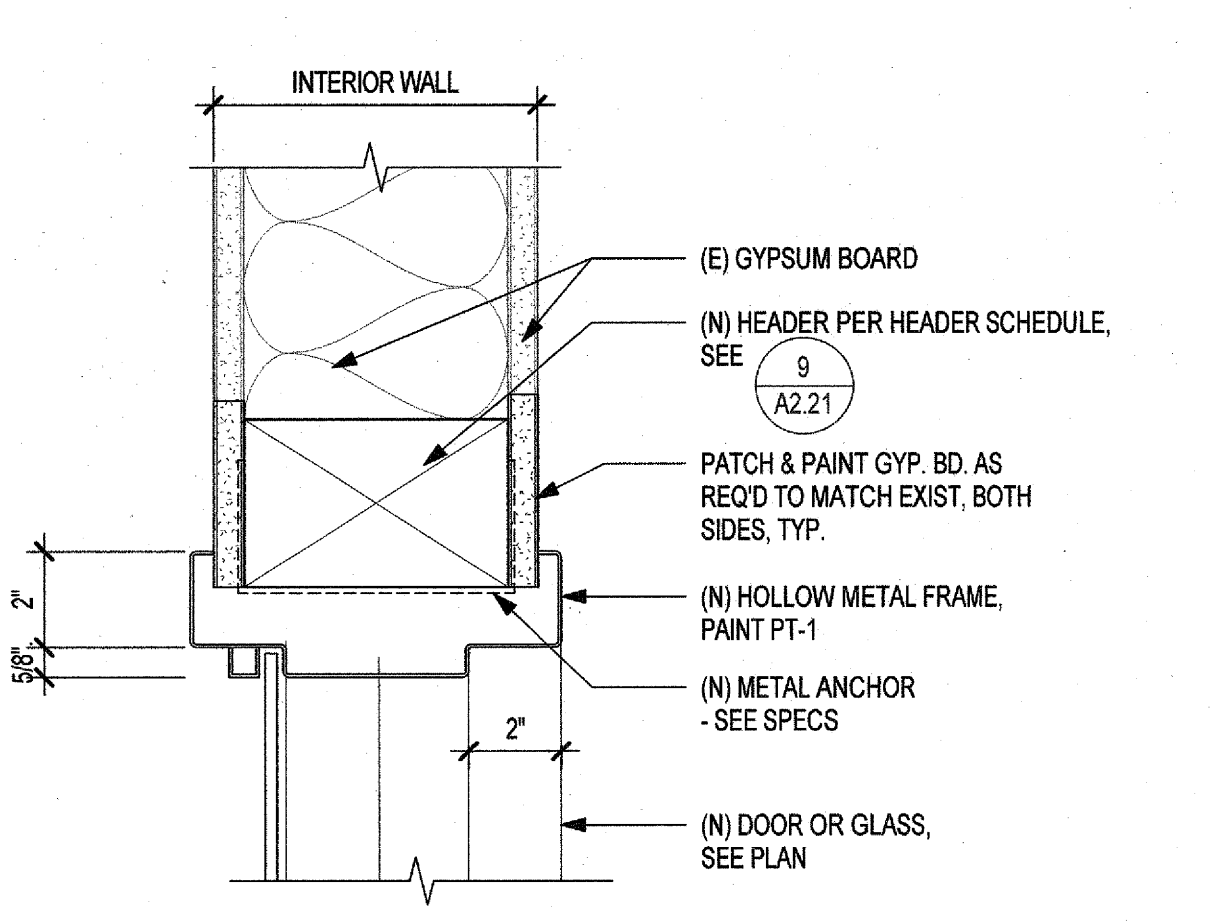


**4 NEW INTERIOR HM FRAME HEAD DETAIL (EXISTING WALL RETROFIT)**  
3" = 1'-0"

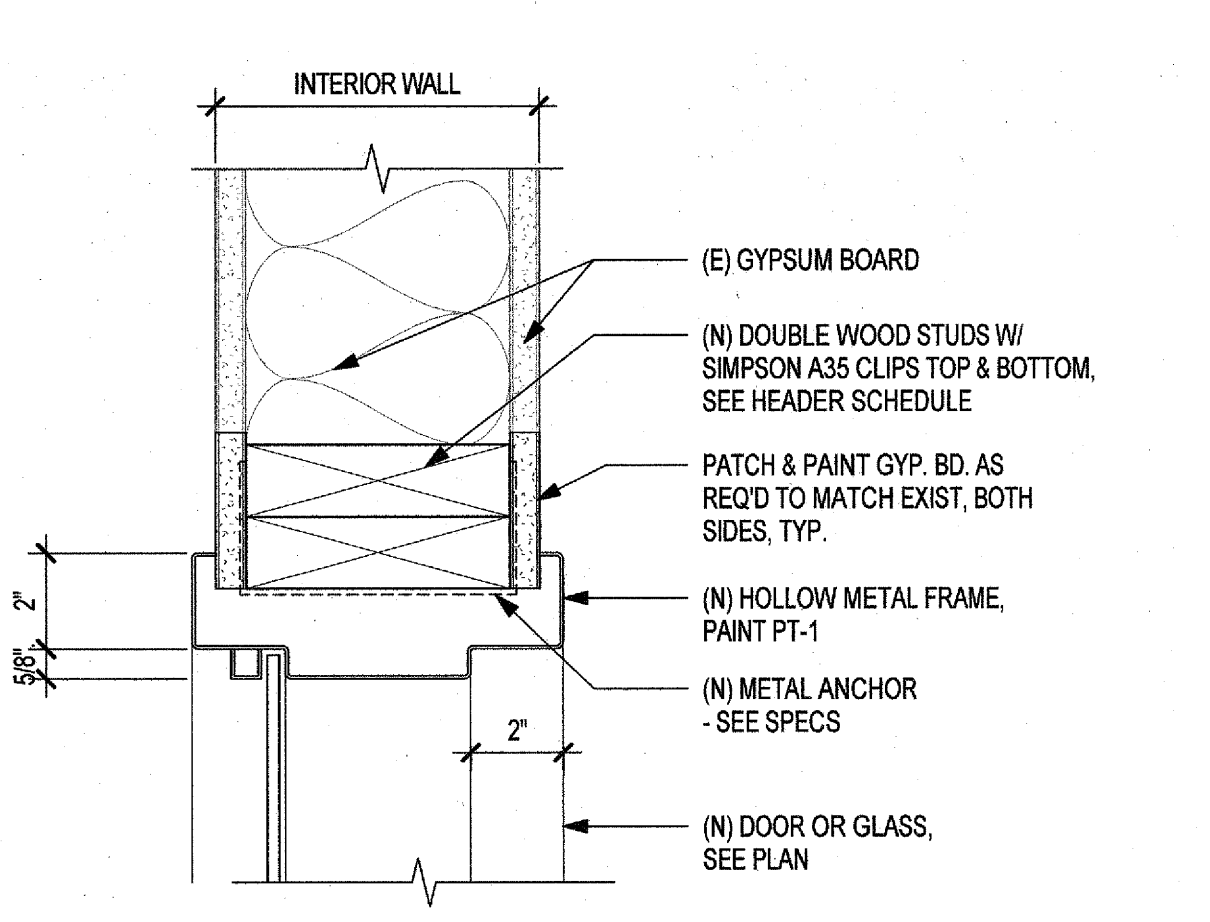


**3 NEW INTERIOR HM FRAME JAMB DETAIL (EXISTING WALL RETROFIT)**  
3" = 1'-0"

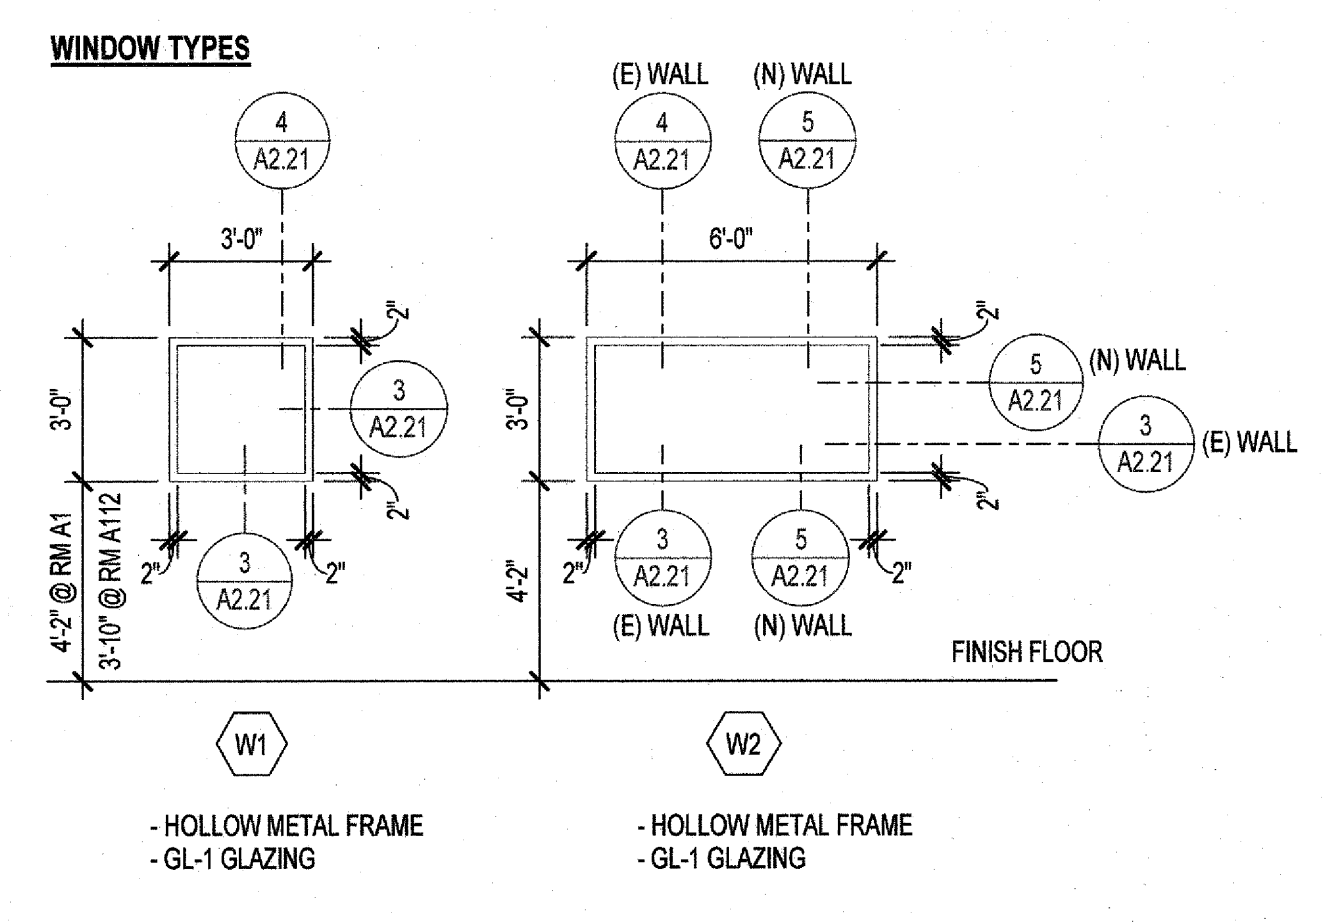

**WINDOW TYPES**

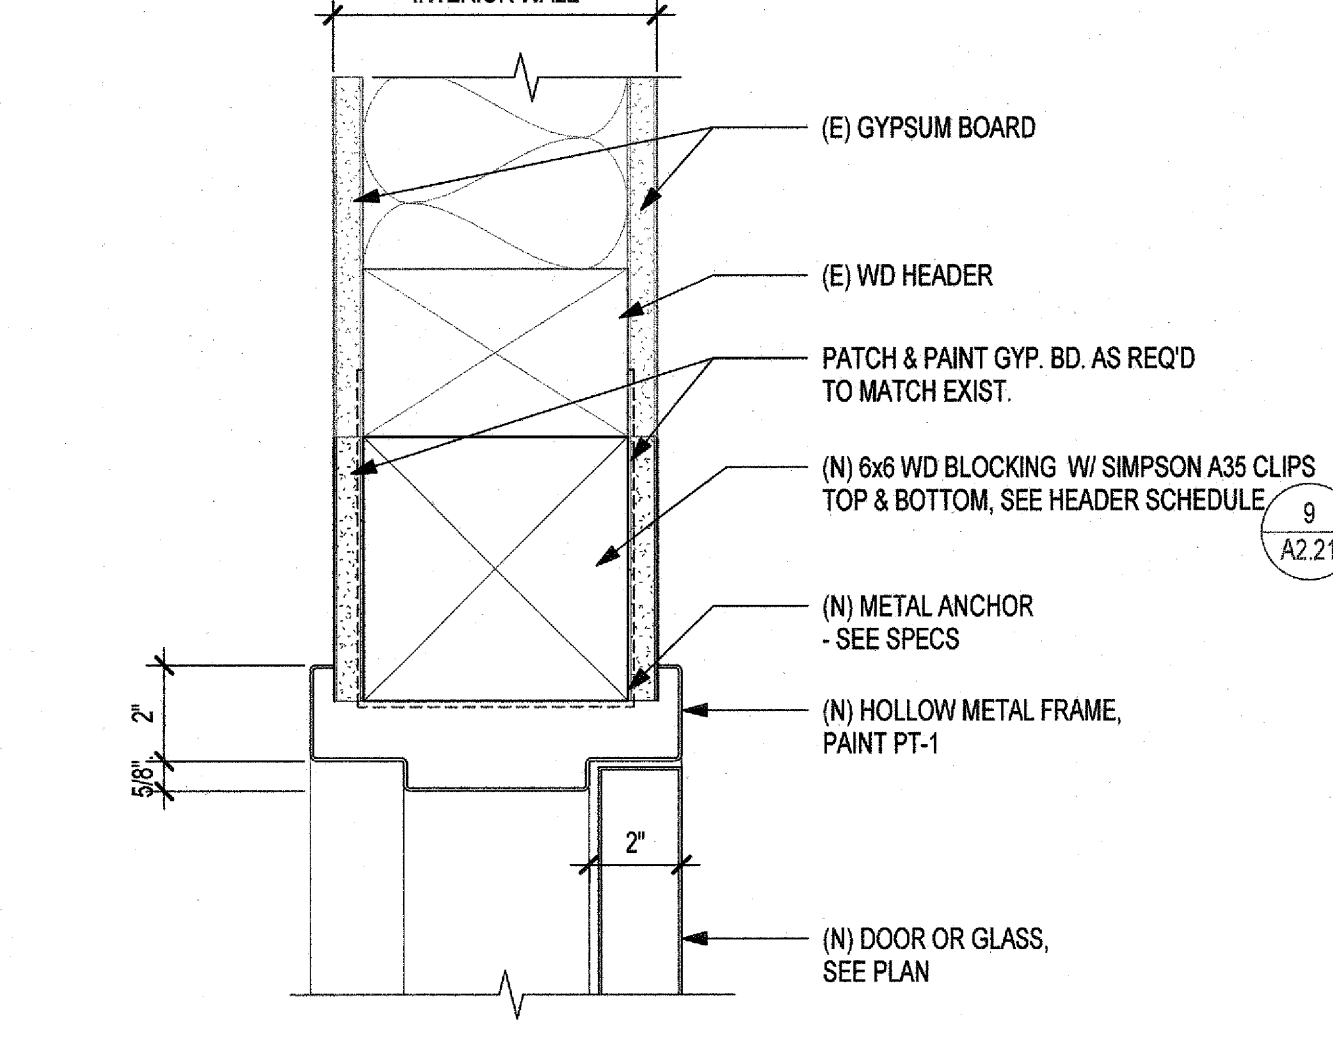

**2 NEW INTERIOR HM FRAME HEAD DETAIL (EXISTING WALL CONSTRUCTION)**  
3" = 1'-0"

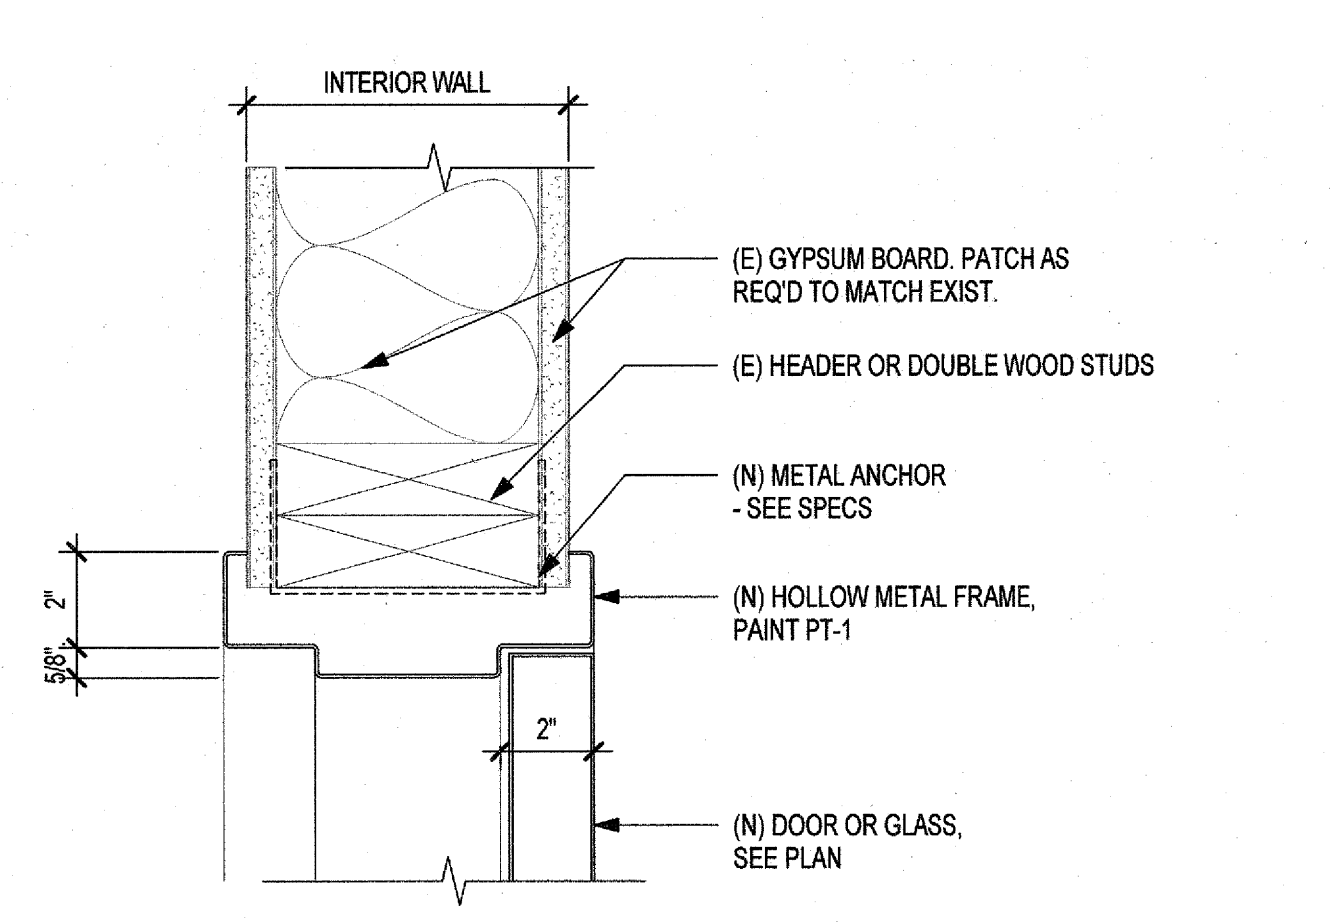

**1 NEW INTERIOR HM FRAME JAMB DETAIL (EXISTING WALL CONSTRUCTION)**  
3" = 1'-0"

SHEET TITLE      DSK JOB NO: 17028

**DOOR & WINDOW SCHEDULE & DETAILS**

SHEET NUMBER

**A2.21**

DRAFTER: JL      PM: JL      REVIEWER: JF

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